

CONTROL POINT	NORTHING	EASTING	ELEVATION	DESCRIPTION
1	7380813.347	1541921.574	4722.64	SET MAG NAIL #100
2	7380612.674	1541909.689	4716.27	SET MAG NAIL #213
1282	7380789.709	1541448.411	4690.94	SET MAG NAIL



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NO.	DATE	REV. BY	DESCRIPTION

REVISIONS

SANDY CITY COMMUNITY ARTS
SANDY, UT

SANDY CITY AMPHITHEATER

DESIGN J. TSANDES	CHECKED J. TSANDES	REVIEW J. TSANDES	VERIFIED SCALE
DRAWN C. GLABAU	APPROVED J. TSANDES	BAR IS ONE INCH ON ORIGINAL DRAWING	

GENERAL

OVERALL SITE PLAN

DATE: JUNE 2023	PROJECT NUMBER: 742-22-01
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IMAGE: GOOGLE EARTH 9-11-2018
P:\Sandy City Community Arts\742-22-01 - Sandy City Amphitheater\2.0 Design Phase\2.7 Drawings\742-22-01_G-05.dwg Plotted: 6/22/2023 2:53 PM By: Cara Glabau



NOTES:

- ① PROPOSED LAWN CHAIR PAVILION. SEE ARCHITECTURAL DRAWINGS.
- ② FRONT OF BUILDING IS 7' FROM EXISTING CONCRETE SIDEWALK.
- ③ BUILDING IS 5' FROM EXISTING FENCE.
- ④ RESTORE ANY CONCRETE OR LANDSCAPING DAMAGED DURING INSTALLATION TO MATCH EXISTING.
- ⑤ INSTALL NEW 4' WIDE SIDEWALK PER SANDY CITY STANDARDS SW-06 ON SHEET C-04.



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SANDY CITY AMPHITHEATER <small>SANDY, UT</small>	VERIFY SCALE <small>BAR IS ONE INCH ON ORIGINAL DRAWING</small>	REVIEW <small>CHECKED: J.TSANDES</small> <small>APPROVED: J.TSANDES</small>	
<small>DESIGN: J.TSANDES</small> <small>DRAWN: C.GLABAU</small>			

LAWN CHAIR PAVILION	<small>DATE: JUNE 2023</small> <small>PROJECT NUMBER: 742-22-01</small>
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NOTES:

- ① PROPOSED MERCHANDISE PAVILION. SEE ARCHITECTURAL DRAWINGS.
- ② REMOVE AND DISPOSE PORTION OF FENCE WHERE BUILDING SHALL BE PLACED.
- ③ INSTALL POSTS AT END OF FENCE, TYING EXISTING FENCE REMAINING INTO BUILDING.
- ④ SAW CUT AND DISPOSE OF EXISTING CONCRETE WHERE BUILDING SHALL BE INSTALLED.
- ⑤ RESTORE ANY CONCRETE OR LANDSCAPING DAMAGED DURING CONSTRUCTION TO MATCH EXISTING CONDITIONS.
- ⑥ PRESERVE AND PROTECT EXISTING FENCE AND GATES.



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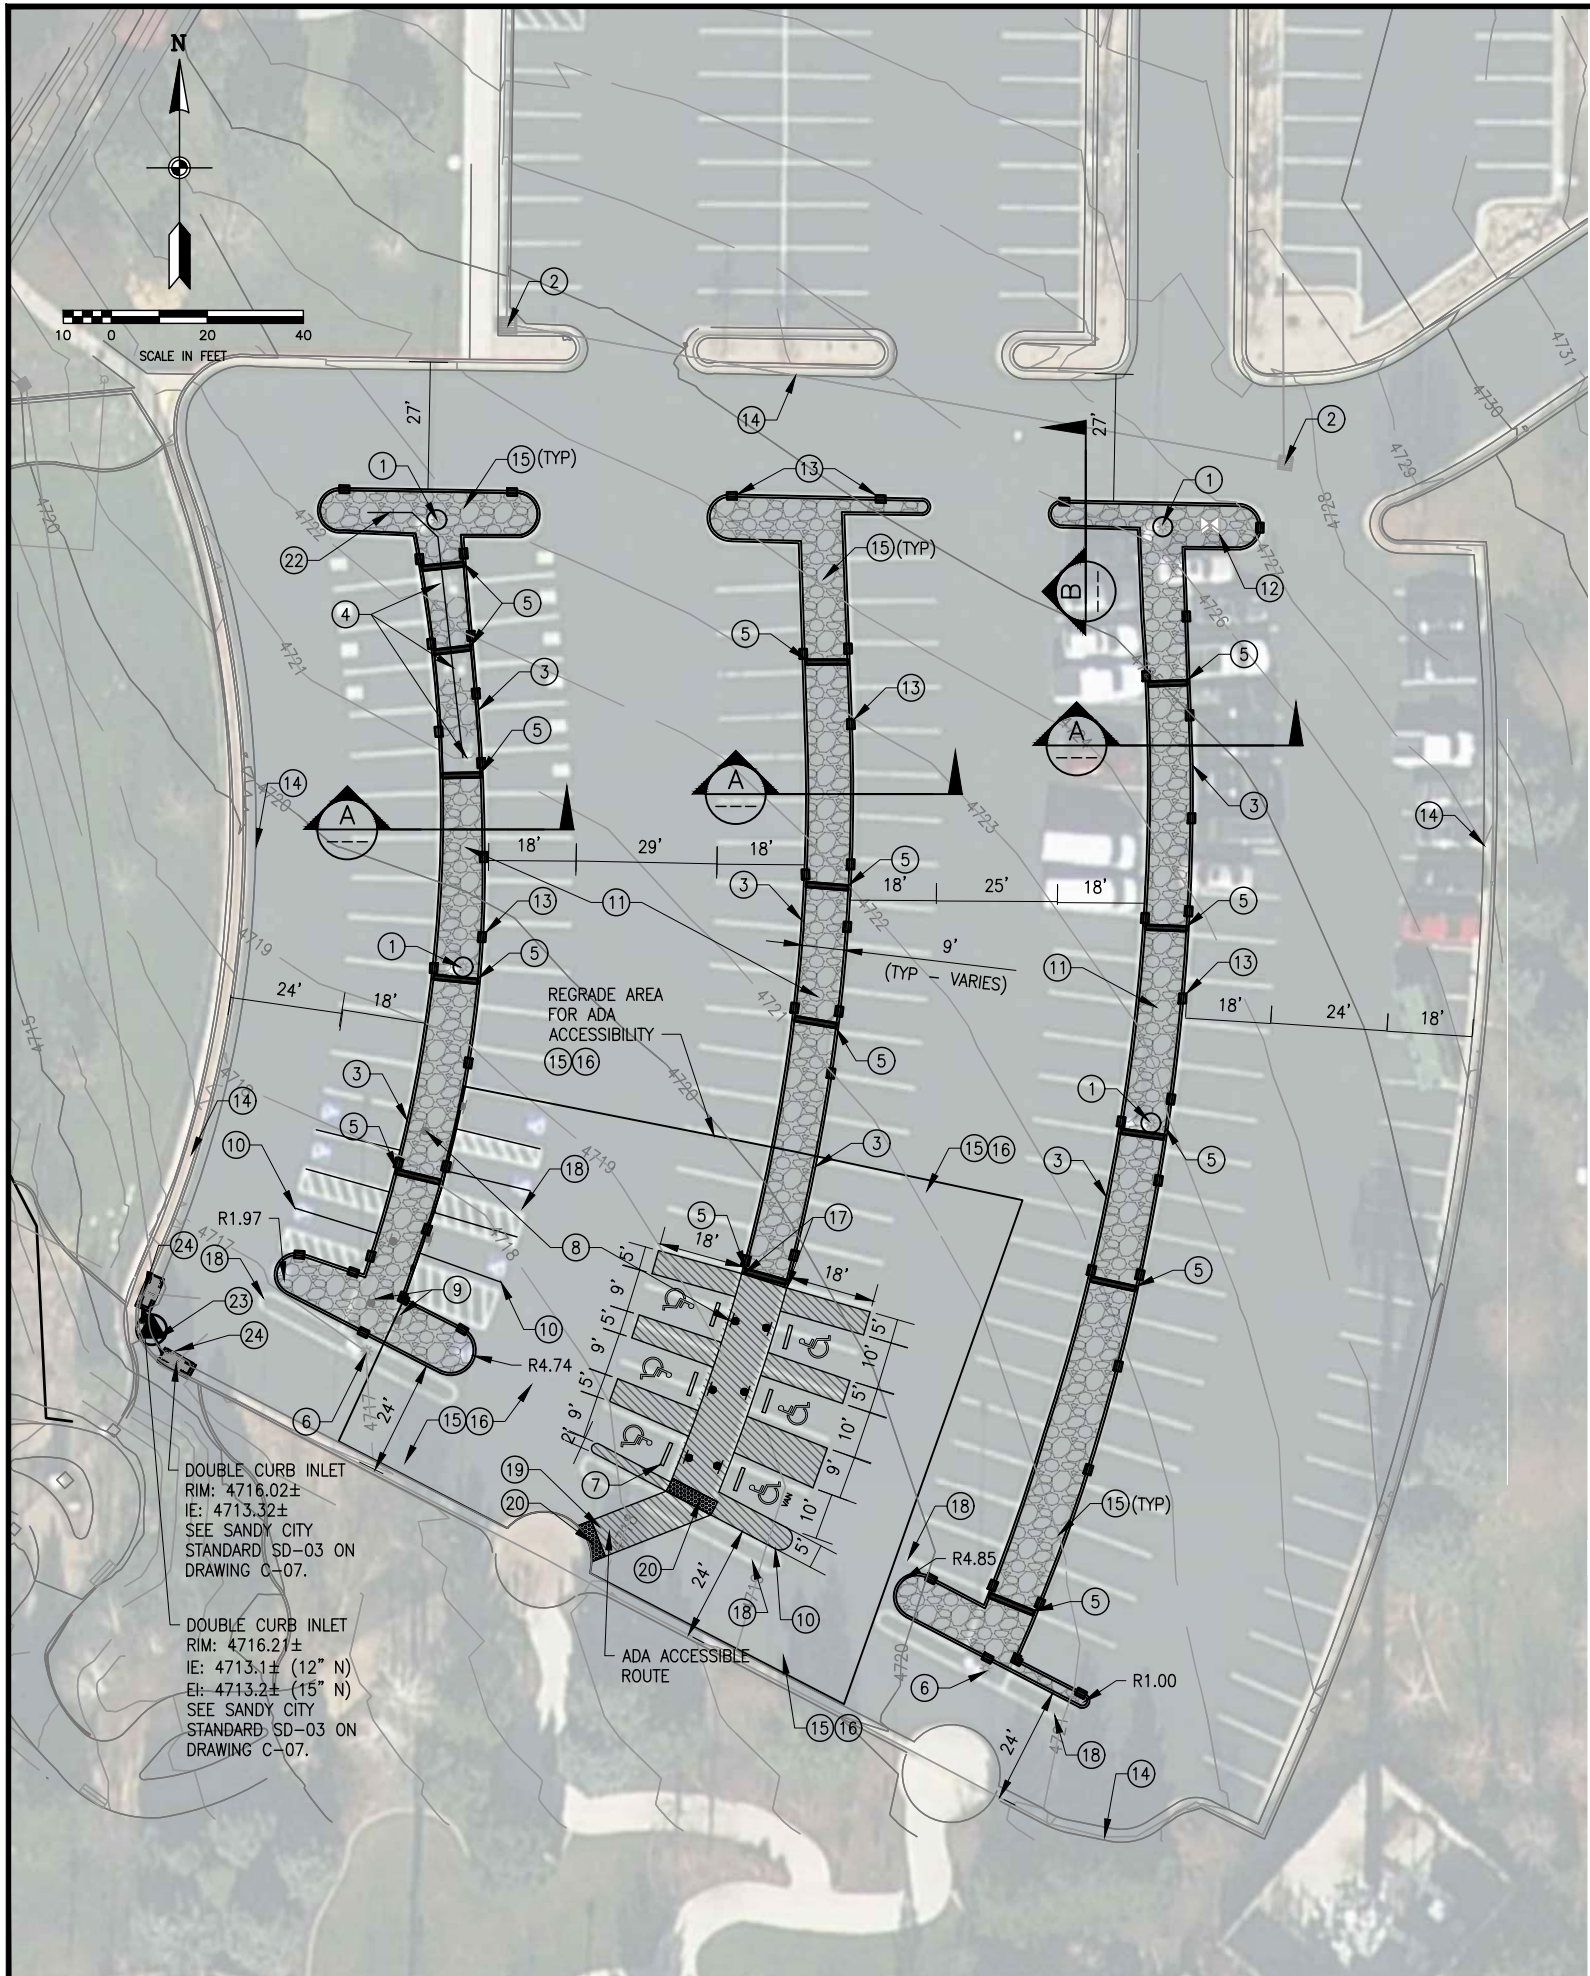
NO.	DATE	REV. BY	DESCRIPTION

SANDY CITY COMMUNITY ARTS SANDY CITY AMPHITHEATER SANDY, UT			
DESIGN DESIGN: J. TSANDES DRAWN: C. GLABAU	REVIEW CHECKED: J. TSANDES APPROVED: J. TSANDES		
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VERIFY SCALE BAR IS ONE INCH ON ORIGINAL DRAWING			

GENERAL MERCHANDISE PAVILION	DATE: JUNE 2023 PROJECT NUMBER: 742-22-01
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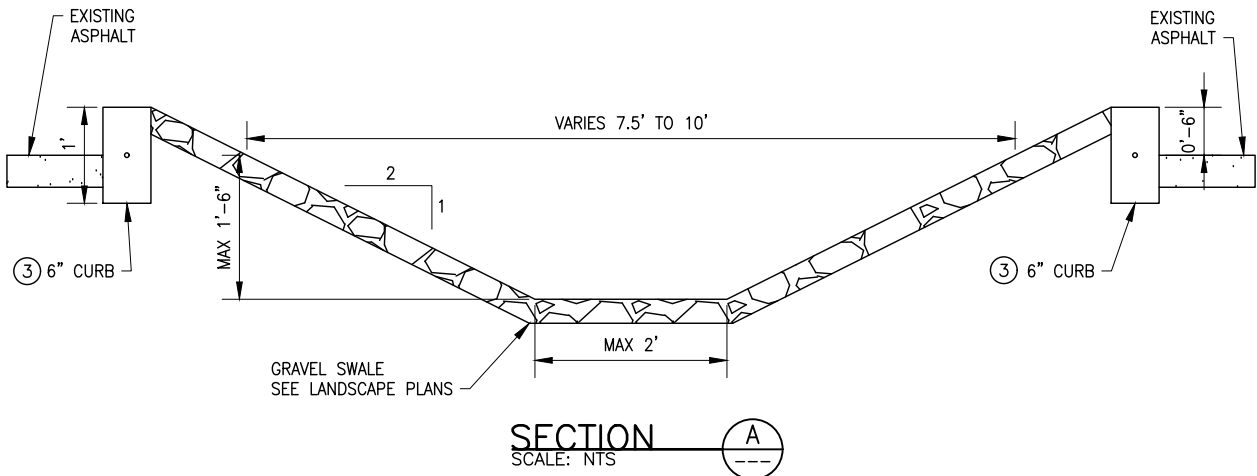
IMAGE: GOOGLE EARTH 9-11-2018

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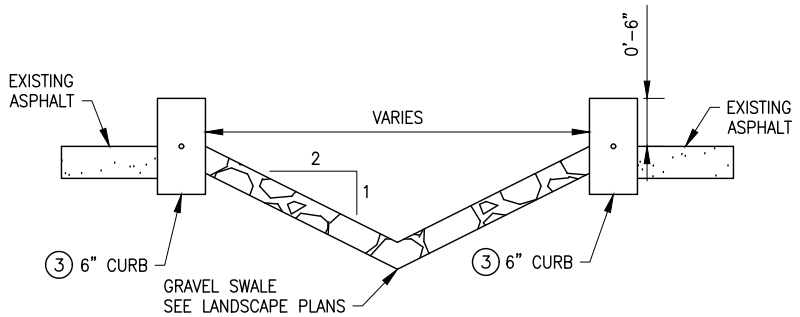


NOTES:

- ① PRESERVE AND PROTECT EXISTING LIGHT POLE.
- ② PRESERVE AND PROTECT EXISTING STORM DRAIN PIPE AND STRUCTURES.
- ③ INSTALL 6" CURB WITH FACE OF CURB ALONG EXISTING PAINT STRIPE, SEE SANDY CITY STANDARD CG-01 ON DRAWING C-04.
- ④ PRESERVE AND PROTECT EV CHARGING STATIONS.
- ⑤ INSTALL EARTHEN CHECK DAM AT A 2:1 SLOPE AS SHOWN. VERIFY LOCATION WITH ENGINEER.
- ⑥ RELOCATE EXISTING LIGHT POLE (SEE ELECTRICAL PLANS).
- ⑦ INSTALL 5' WHEEL STOP (TYP 6). SEE DRAWING C-08.
- ⑧ RELOCATE HANDICAP PARKING SIGNS (TYP 6) TO NEW ADA ACCESSIBLE PARKING STALLS.
- ⑨ REMOVE HANDICAP PARKING SIGNS (TYP).
- ⑩ RESTRIPE PARKING STALLS (TYP).
- ⑪ INSTALL DRAINAGE SWALES AS SHOWN.
- ⑫ RAISE/LOWER EXISTING VALVE BOX PER SANDY CITY REQUIREMENTS.
- ⑬ 2' CURB CUT (TYP 40). VERIFY LOCATION WITH ENGINEER. SLOPE CUTS AT 1:1.
- ⑭ PRESERVE AND PROTECT EXISTING CURB AND GUTTER.
- ⑮ SAWCUT, REMOVE, AND DISPOSE OF EXISTING ASPHALT. REGRADE ASPHALT PER GRADING PLAN BY RAISING/LOWERING GRADES MAINTAINING A MINIMUM OF 8" THICK BASE COURSE.
- ⑯ NEW 4" COMPACTED 1/2" HMA OVER 8" COMPACTED BASE COURSE. INSTALL OVER PROPERLY PREPARED SUBGRADE. ALL EDGES OF EXISTING ASPHALT SHALL BE CLEAN, SAWCUT & BITUMINOUS TACK COAT APPLIED PRIOR TO NEW ASPHALT BEING PLACED.
- ⑰ END OF 6" CURB. RESTRIPE LINES SOUTH OF THIS POINT TO BE USED AS ADA ACCESSIBLE PARKING AND ROUTE.
- ⑱ REMOVE EXISTING PARKING STRIPING.
- ⑲ PAINT NEW WHITE STRIPING AT ROAD GRADE.
- ⑳ INSTALL DETECTABLE WARNING SURFACE ON EITHER SIDE OF DRIVE AISLE. SEE SANDY CITY STANDARD SW-01 ON DRAWING C-05.
- ㉑ ALL PARKING STALL AND DRIVE AISLE DIMENSIONS ARE TO FACE OF CURB.
- ㉒ PRESERVE AND PROTECT EXISTING EV CHARGING STATION POWER.
- ㉓ 12 LF 15" ADS N-12 PIPE @ 1%.
- ㉔ REMOVE AND DISPOSE OF EXISTING STORM DRAIN CATCH BASIN AND 12" PIPE BETWEEN BOXES. PLUG EXISTING 12" PIPE HEADING WEST DOWN THE HILL. REPAIR ALL ASPHALT, CURB AND GUTTER, LANDSCAPING, ETC. TO MATCH EXISTING.



SECTION A
SCALE: NTS



SECTION B
SCALE: NTS



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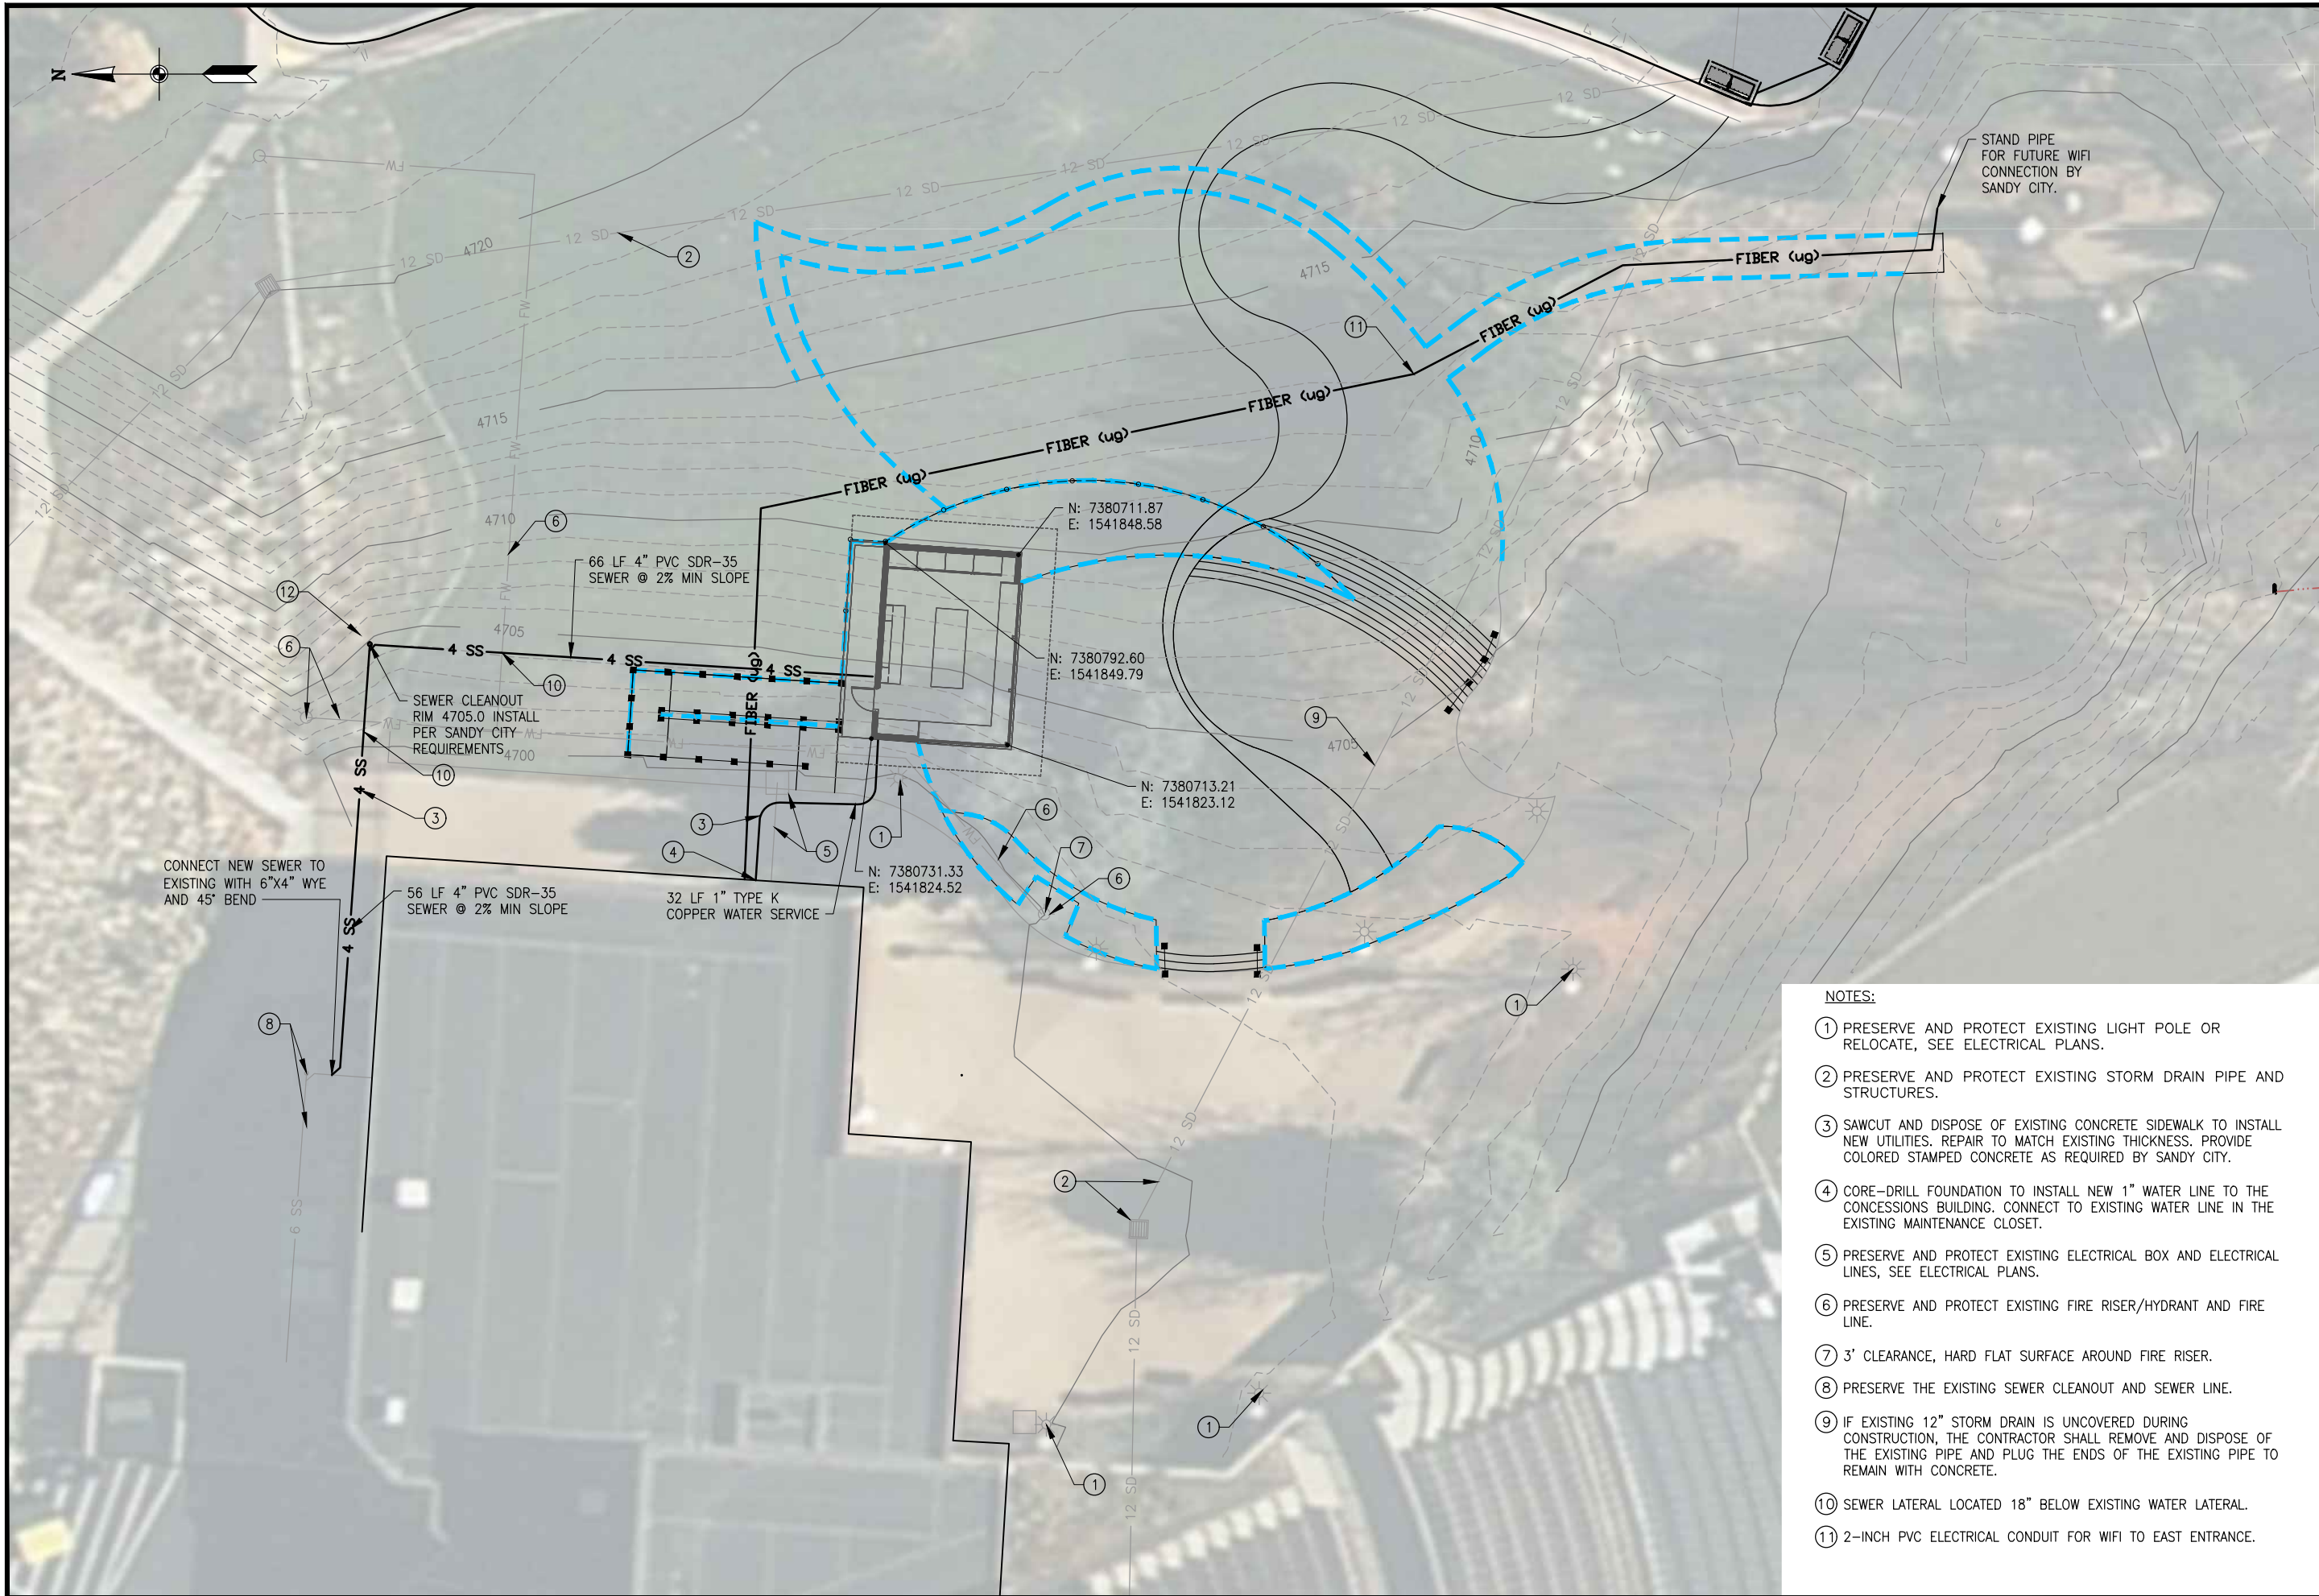
SANDY CITY AMPHITHEATER
SANDY, UT

DESIGN DESIGN A. DEVENPORT DRAWN A. DEVENPORT	REVIEW CHECKED E. NEIL APPROVED E. NEIL	VERIFY SCALE BAR IS ONE INCH ON ORIGINAL DRAWING
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PARKING LOT SITE PLAN
AND UTILITIES

DATE: JUNE 2023
PROJECT NUMBER 74222-01

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- NOTES:**
- ① PRESERVE AND PROTECT EXISTING LIGHT POLE OR RELOCATE, SEE ELECTRICAL PLANS.
 - ② PRESERVE AND PROTECT EXISTING STORM DRAIN PIPE AND STRUCTURES.
 - ③ SAWCUT AND DISPOSE OF EXISTING CONCRETE SIDEWALK TO INSTALL NEW UTILITIES. REPAIR TO MATCH EXISTING THICKNESS. PROVIDE COLORED STAMPED CONCRETE AS REQUIRED BY SANDY CITY.
 - ④ CORE-DRILL FOUNDATION TO INSTALL NEW 1" WATER LINE TO THE CONCESSIONS BUILDING. CONNECT TO EXISTING WATER LINE IN THE EXISTING MAINTENANCE CLOSET.
 - ⑤ PRESERVE AND PROTECT EXISTING ELECTRICAL BOX AND ELECTRICAL LINES, SEE ELECTRICAL PLANS.
 - ⑥ PRESERVE AND PROTECT EXISTING FIRE RISER/HYDRANT AND FIRE LINE.
 - ⑦ 3' CLEARANCE, HARD FLAT SURFACE AROUND FIRE RISER.
 - ⑧ PRESERVE THE EXISTING SEWER CLEANOUT AND SEWER LINE.
 - ⑨ IF EXISTING 12" STORM DRAIN IS UNCOVERED DURING CONSTRUCTION, THE CONTRACTOR SHALL REMOVE AND DISPOSE OF THE EXISTING PIPE AND PLUG THE ENDS OF THE EXISTING PIPE TO REMAIN WITH CONCRETE.
 - ⑩ SEWER LATERAL LOCATED 18" BELOW EXISTING WATER LATERAL.
 - ⑪ 2-INCH PVC ELECTRICAL CONDUIT FOR WIFI TO EAST ENTRANCE.



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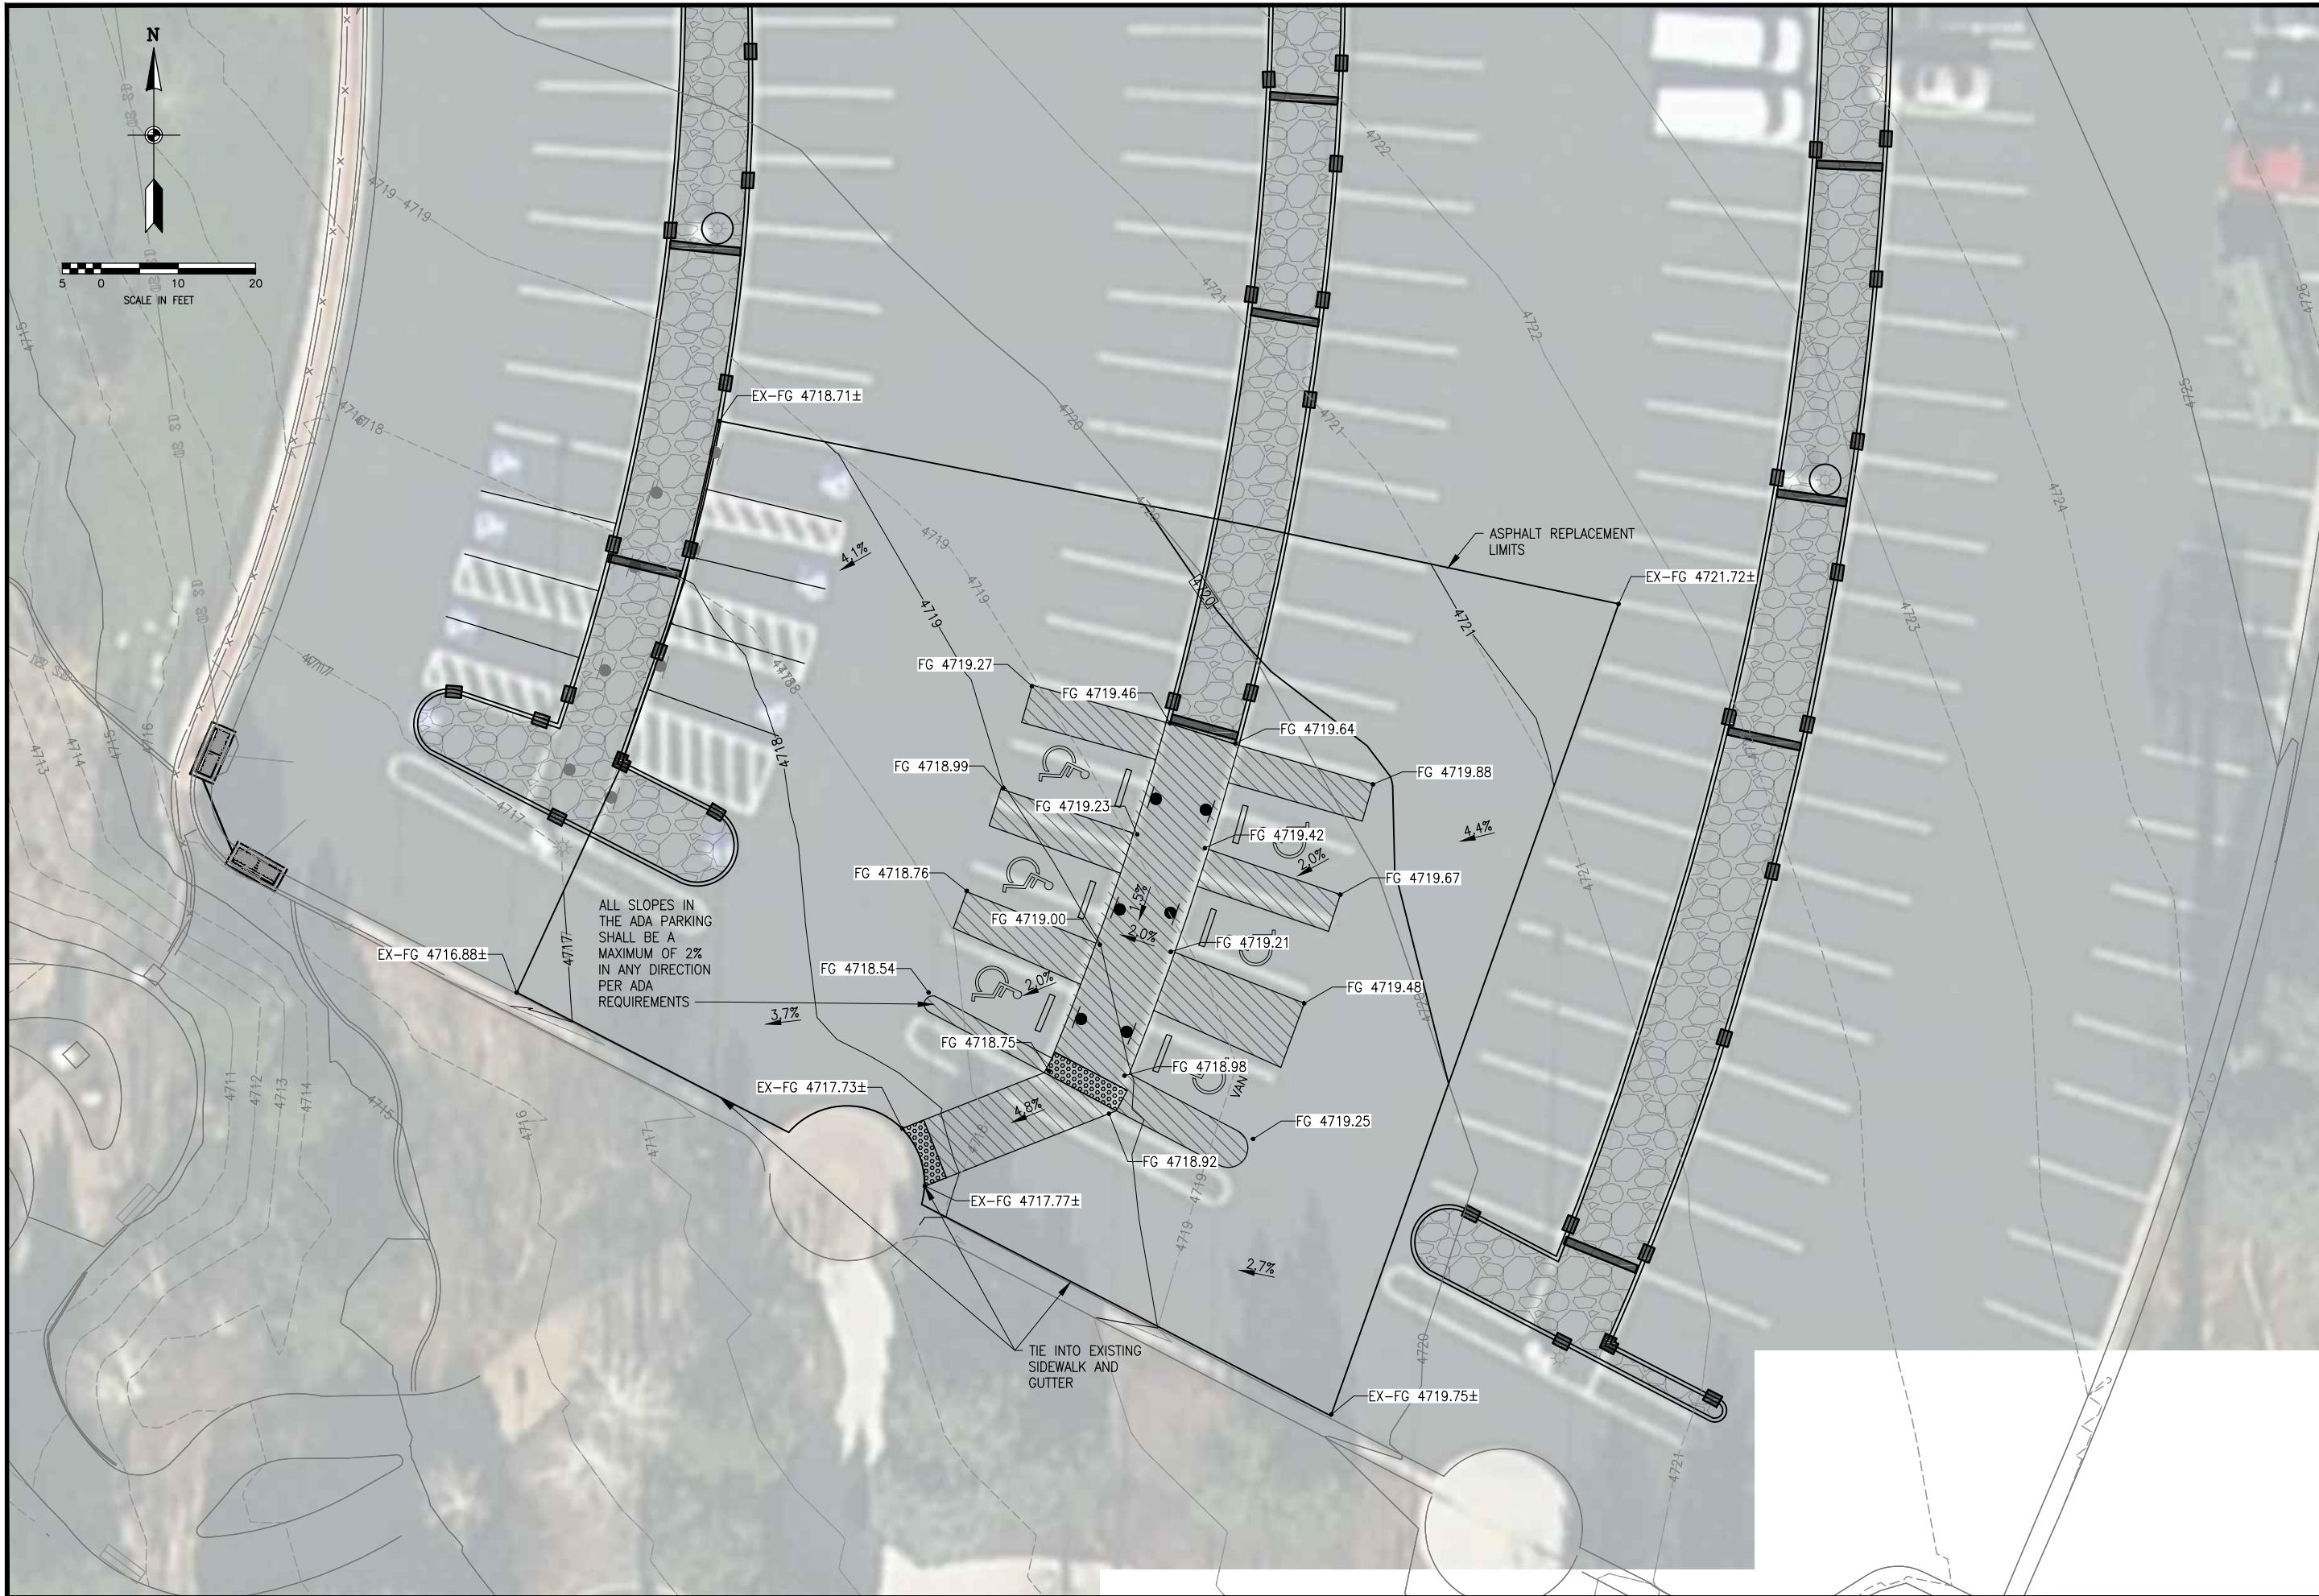
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SANDY CITY COMMUNITY ARTS SANDY, UT	
SANDY CITY AMPHITHEATER	VERIFY SCALE BAR IS ONE INCH ON ORIGINAL DRAWING
DESIGN DESIGN A. DEVENPORT DRAWN A. DEVENPORT	REVIEW CHECKED E. NEIL APPROVED E. NEIL

PLAZA SITE PLAN
AND UTILITIES

DATE: JUNE 2023
PROJECT NUMBER: 742-22-01

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BAR IS ONE INCH ON ORIGINAL DRAWING

SANDY CITY COMMUNITY ARTS
SANDY, UT

SANDY CITY AMPHITHEATER

DESIGN	REVIEW	CHECKED	APPROVED
DESIGN A. DEVENPORT DRAWN A. DEVENPORT	REVIEW E. NEIL	CHECKED E. NEIL	APPROVED E. NEIL

DATE: JUNE 2023
PROJECT NUMBER: 742-22-01

DRAWING NO.
C-03

SHEET 10 OF 26

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NO.	DATE	REV. BY	DESCRIPTION

SANDY CITY AMPHITHEATER
SANDY, UT

DESIGN	REVIEW	VERIFY SCALE
DESIGN: J. TSANDES DRAWN: C. GLABAU	CHECKED: J. TSANDES APPROVED: J. TSANDES	BAR IS ONE INCH ON ORIGINAL DRAWING

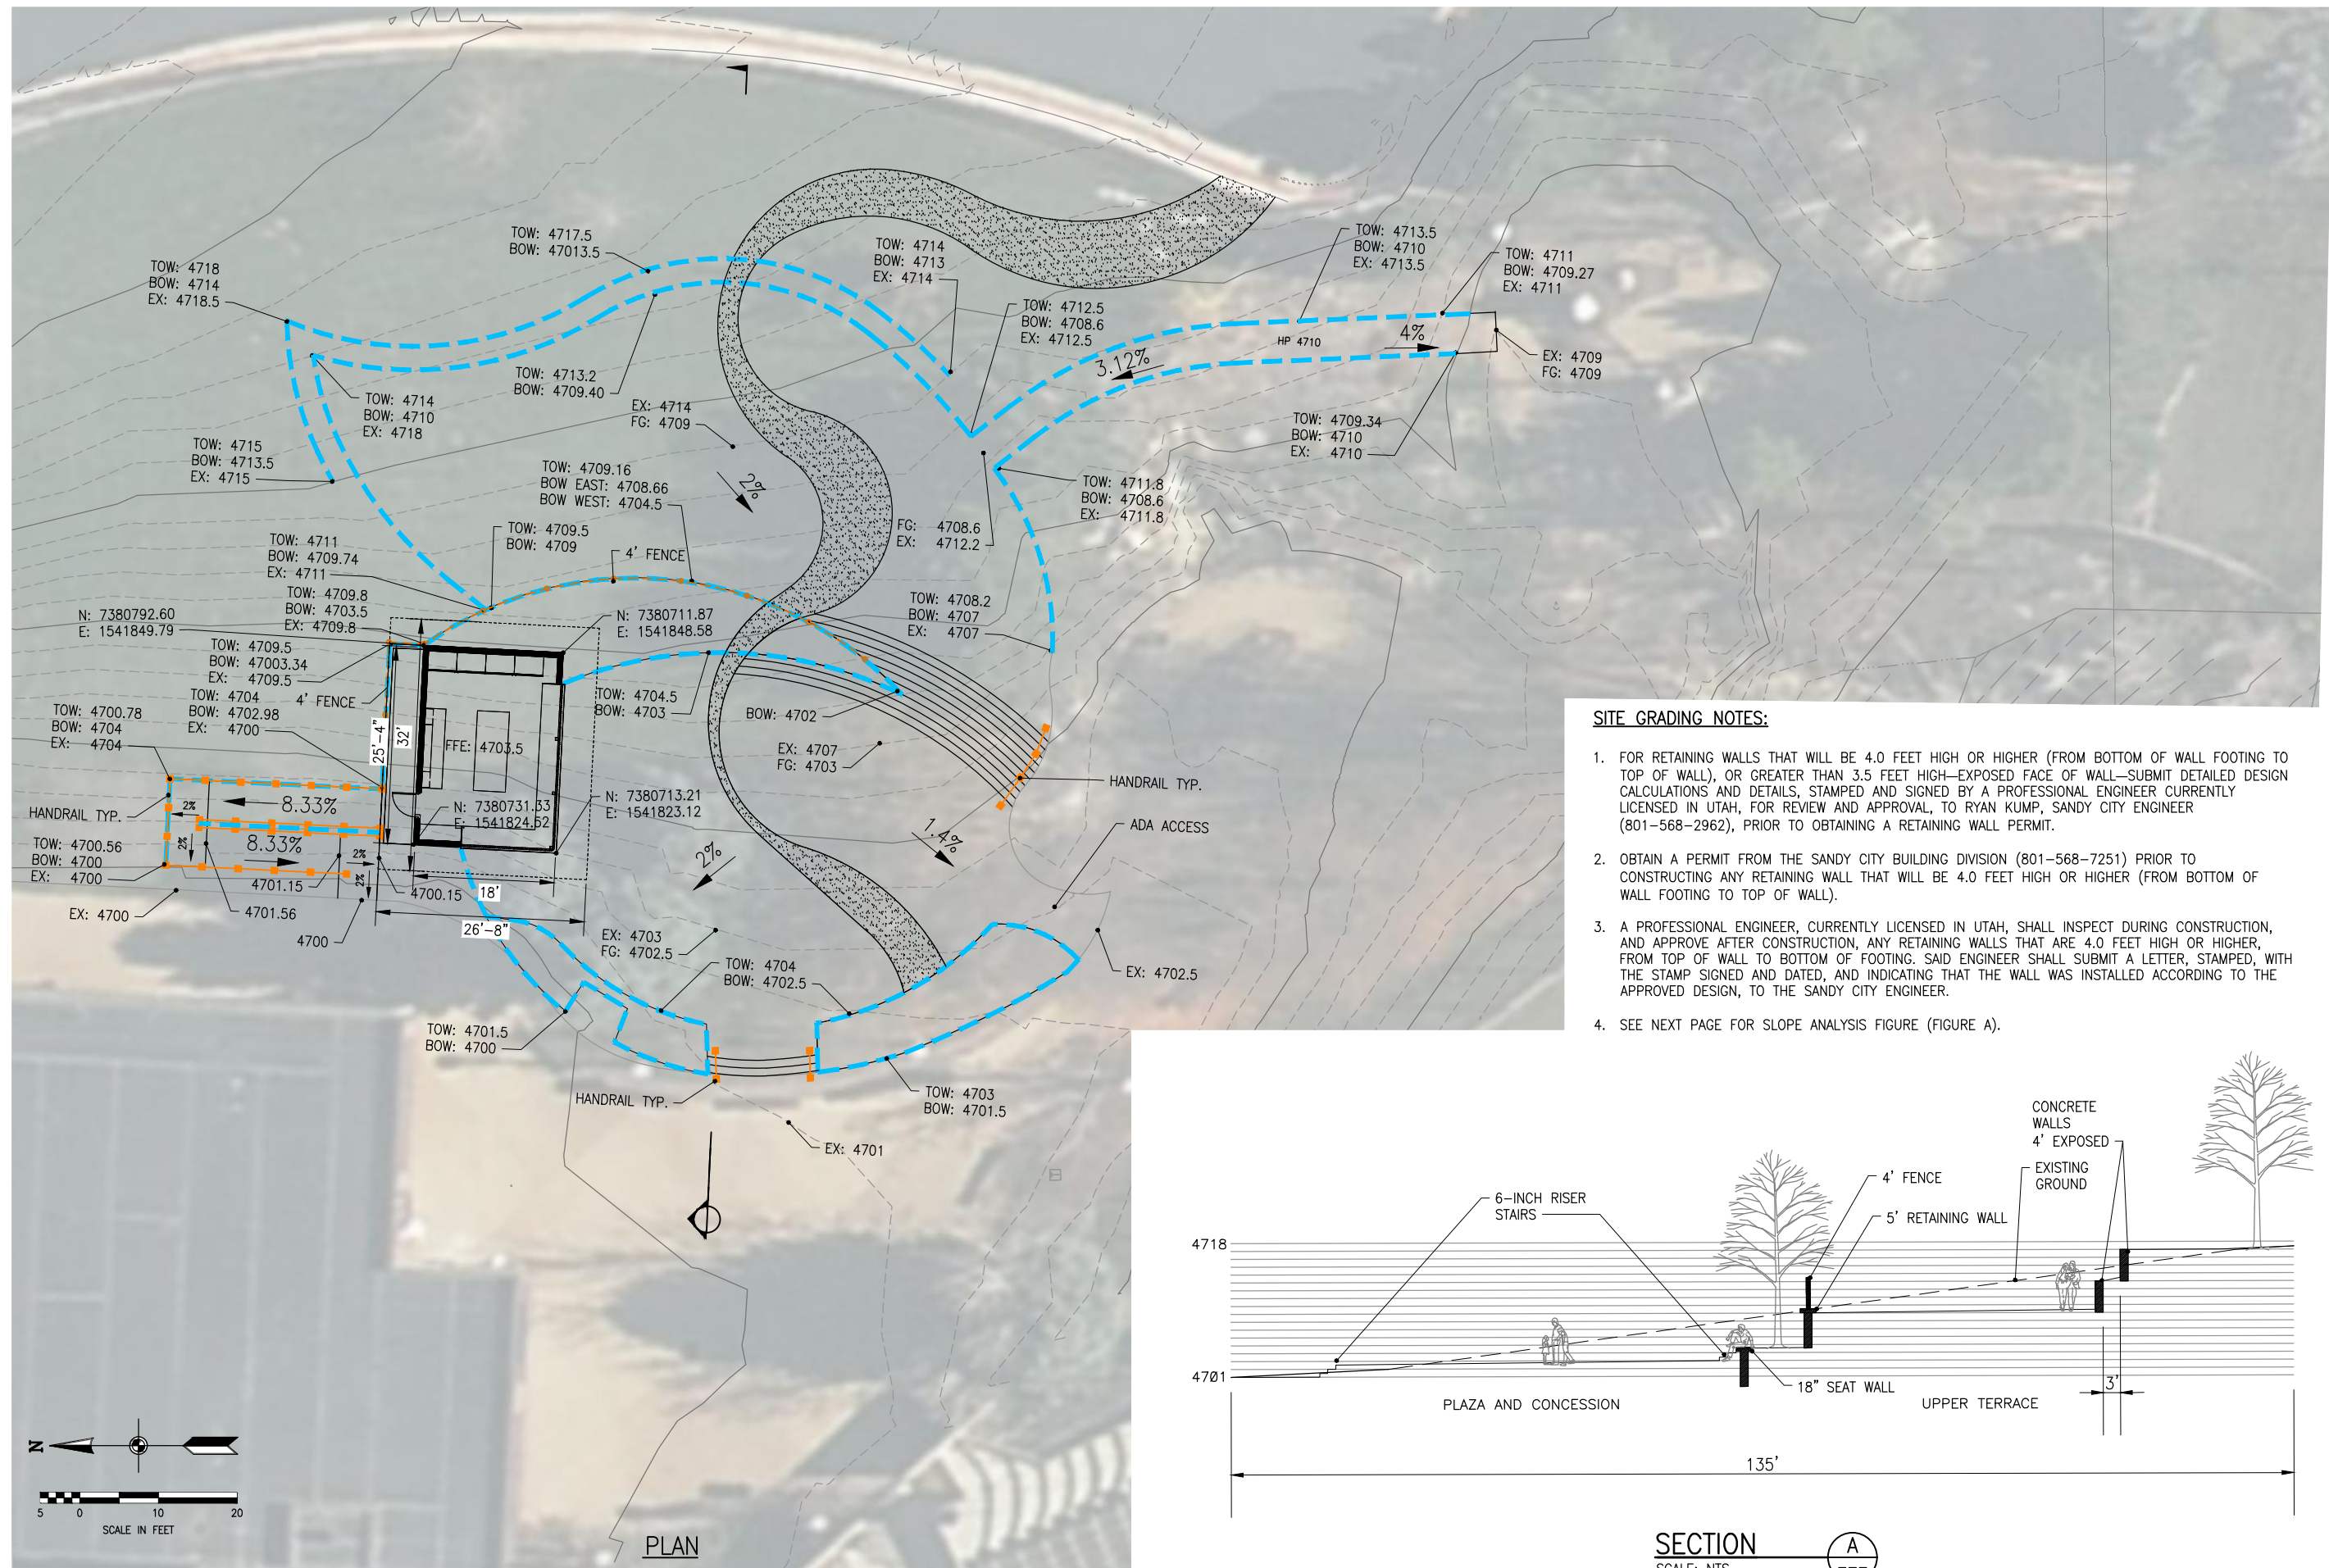
LANDSCAPE

PLAZA GRADING PLAN


DATE: JUNE 2023 PROJECT NUMBER: 742-22-01



DRAWING NO. **L-01**

SHEET **16** OF **26**



- SITE GRADING NOTES:**
- FOR RETAINING WALLS THAT WILL BE 4.0 FEET HIGH OR HIGHER (FROM BOTTOM OF WALL FOOTING TO TOP OF WALL), OR GREATER THAN 3.5 FEET HIGH—EXPOSED FACE OF WALL—SUBMIT DETAILED DESIGN CALCULATIONS AND DETAILS, STAMPED AND SIGNED BY A PROFESSIONAL ENGINEER CURRENTLY LICENSED IN UTAH, FOR REVIEW AND APPROVAL, TO RYAN KUMP, SANDY CITY ENGINEER (801-568-2962), PRIOR TO OBTAINING A RETAINING WALL PERMIT.
 - OBTAIN A PERMIT FROM THE SANDY CITY BUILDING DIVISION (801-568-7251) PRIOR TO CONSTRUCTING ANY RETAINING WALL THAT WILL BE 4.0 FEET HIGH OR HIGHER (FROM BOTTOM OF WALL FOOTING TO TOP OF WALL).
 - A PROFESSIONAL ENGINEER, CURRENTLY LICENSED IN UTAH, SHALL INSPECT DURING CONSTRUCTION, AND APPROVE AFTER CONSTRUCTION, ANY RETAINING WALLS THAT ARE 4.0 FEET HIGH OR HIGHER, FROM TOP OF WALL TO BOTTOM OF FOOTING. SAID ENGINEER SHALL SUBMIT A LETTER, STAMPED, WITH THE STAMP SIGNED AND DATED, AND INDICATING THAT THE WALL WAS INSTALLED ACCORDING TO THE APPROVED DESIGN, TO THE SANDY CITY ENGINEER.
 - SEE NEXT PAGE FOR SLOPE ANALYSIS FIGURE (FIGURE A).

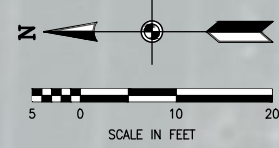

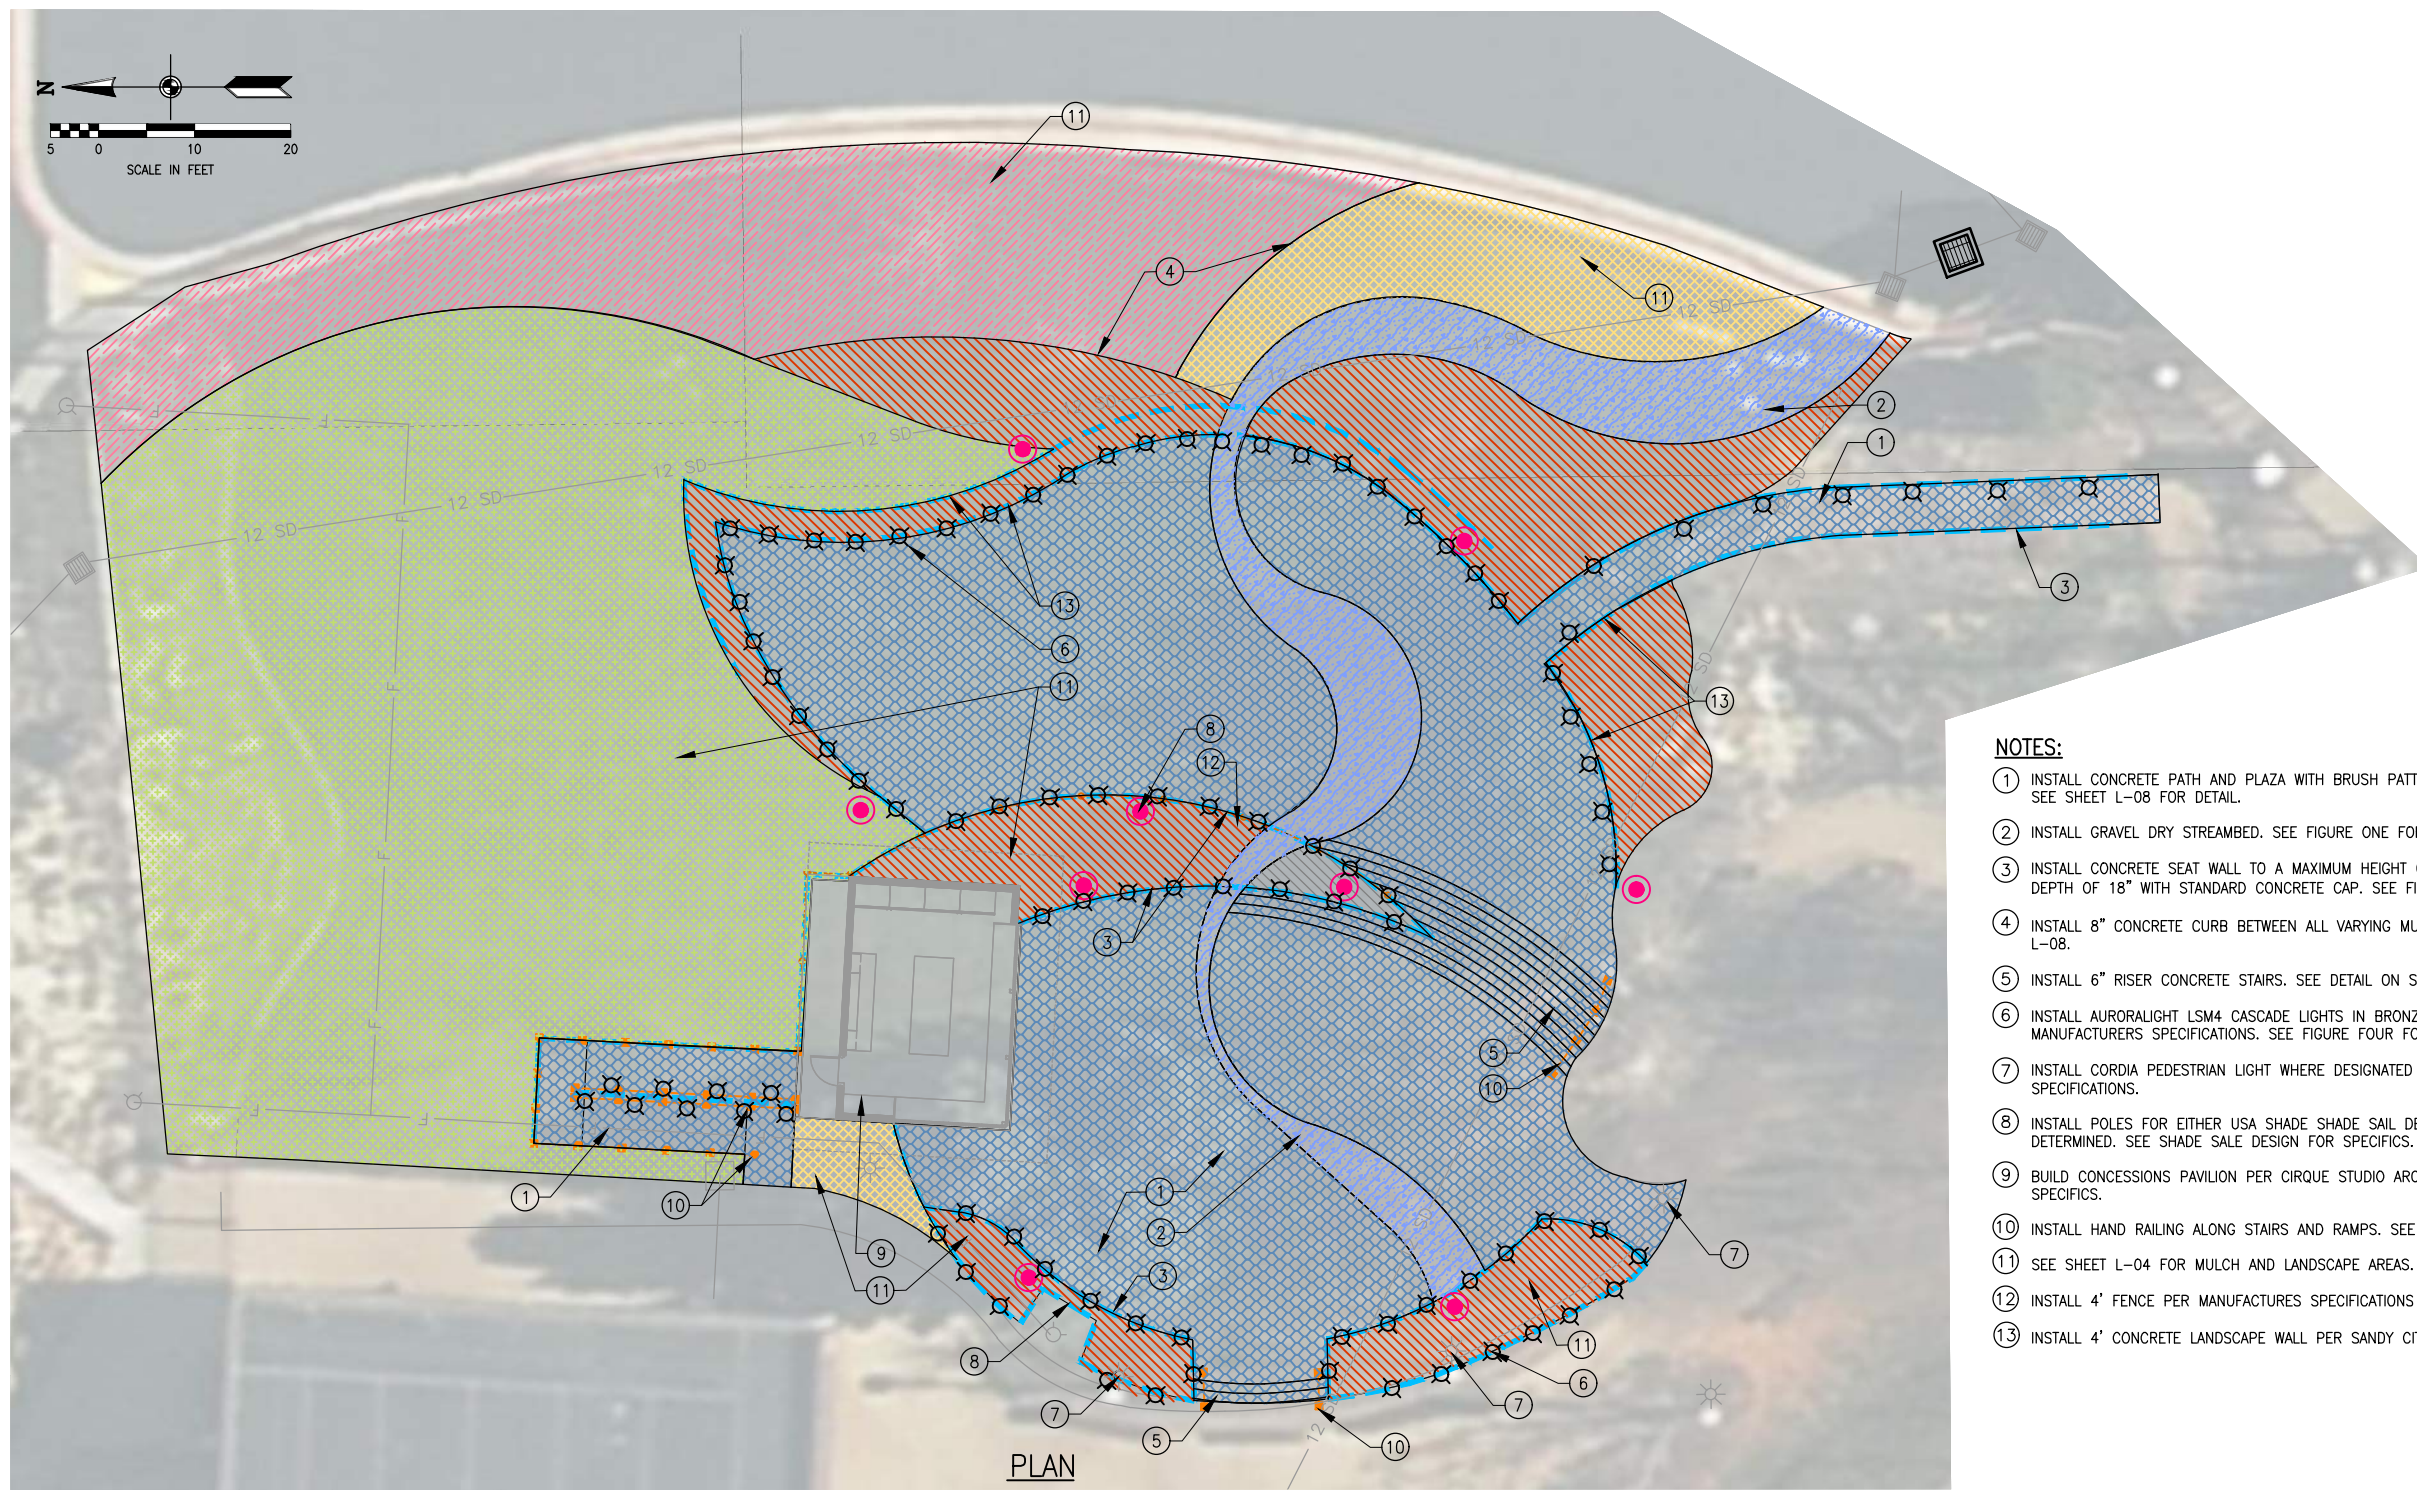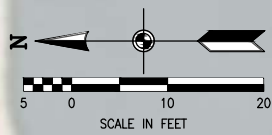

NOTES:

- ① INSTALL CONCRETE PATH AND PLAZA WITH BRUSH PATTERN CONCRETE. COLOR TO BE DETERMINED BY CITY. SEE SHEET L-08 FOR DETAIL. (L 2806)
- ② INSTALL GRAVEL DRY STREAMBED. SEE FIGURE ONE FOR MATERIALS EXAMPLE.
- ③ INSTALL CONCRETE SEAT WALL TO A MAXIMUM HEIGHT OF 24" (HEIGHT VARIES BASED ON LOCATION) AND A DEPTH OF 18" WITH STANDARD CONCRETE CAP. SEE FIGURES TWO AND THREE FOR MATERIAL EXAMPLES.
- ④ INSTALL 8" CONCRETE CURB BETWEEN ALL VARYING MULCH/GROUND COVER MATERIALS PER DETAIL ON SHEET L-08. (L 2801)
- ⑤ INSTALL 6" RISER CONCRETE STAIRS. SEE DETAIL ON SHEET L-08. (L 2884)
- ⑥ INSTALL AURORALIGHT LSM4 CASCADE LIGHTS IN BRONZE EVERY 5 FT WITHIN SEAT WALLS PER MANUFACTURERS SPECIFICATIONS. SEE FIGURE FOUR FOR EXAMPLE AND SHEET L-11 FOR SPECIFICATIONS.
- ⑦ INSTALL CORDIA PEDESTRIAN LIGHT WHERE DESIGNATED (3) IN DARK CORTEN TEXTURE. SEE SHEET L-10 FOR SPECIFICATIONS.
- ⑧ INSTALL POLES FOR EITHER USA SHADE SHADE SAIL DESIGN OR BISTRO LIGHTS. POLE STYLE AND SIZE TO BE DETERMINED. SEE SHADE SALE DESIGN FOR SPECIFICS. SEE FIGURE FIVE FOR BISTRO LIGHTING EXAMPLE.
- ⑨ BUILD CONCESSIONS PAVILION PER CIRQUE STUDIO ARCHITECTS DESIGN. SEE ARCHITECTURAL DRAWINGS FOR SPECIFICS.
- ⑩ INSTALL HAND RAILING ALONG STAIRS AND RAMPS. SEE DETAIL ON SHEET L-07. (L 2815)
- ⑪ SEE SHEET L-04 FOR MULCH AND LANDSCAPE AREAS.
- ⑫ INSTALL 4' FENCE PER MANUFACTURES SPECIFICATIONS ON CONCRETE WALL. SEE DETAIL ON SHEET L-07. (L 2817)
- ⑬ INSTALL 4' CONCRETE LANDSCAPE WALL PER SANDY CITY STANDARDS. SEE SHEET L-10.

IMAGE: GOOGLE EARTH 9-11-2018



FIGURE ONE
DRY STREAM BED MATERIALS



FIGURE TWO
SEAT WALL CONCRETE CAP MATERIALS



FIGURE THREE
CONCRETE SEAT WALL MATERIAL



FIGURE FOUR
CONCRETE SEAT WALL LIGHTING



FIGURE FIVE
BISTRO STRING LIGHT EXAMPLE


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SANDY CITY AMPHITHEATER SANDY, UT	DESIGN DESIGN: J. TSANDES DRAWN: J. TSANDES	REVIEW CHECKED: J. TSANDES APPROVED: J. TSANDES	VERIFY SCALE BAR IS ONE INCH ON ORIGINAL DRAWING
	SANDY CITY COMMUNITY ARTS		

LANDSCAPE PLAZA SITE PLAN	DATE: JUNE 2023 PROJECT NUMBER: 742-22-01
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PLANT SCHEDULE PARKING			
TREES	BOTANICAL / COMMON NAME	SIZE	QTY
○	CARPINUS BETULUS 'FRANS FONTAINE' FRANS FONTAINE HORNBEAM	2" CAL	23
SHRUBS	BOTANICAL / COMMON NAME	SIZE	QTY
⊕	CARYOPTERIS X CLANDONENSIS 'LONGWOOD BLUE' LONGWOOD BLUE BLUEBEARD	5 GAL	8
⊕	PHYSOCARPUS OPULIFOLIUS 'NUGGET' NUGGET NINEBARK	5 GAL	4
⊕	POTENTILLA FRUTICOSA 'GOLDFINGER' GOLDFINGER BUSH CINQUEFOIL	5 GAL	84
⊕	PRUNUS BESSEYI 'P011S' PAWNEE BUTTES® SAND CHERRY	5 GAL	60
⊕	RIBES ALPINUM ALPINE CURRANT	5 GAL	1
ANNUALS/PERENNIALS	BOTANICAL / COMMON NAME	SIZE	QTY
⊕	CENTRANTHUS RUBER 'ROSEUS' PINK VALERIAN	1 GAL	34
⊕	HEMEROCALLIS X 'STELLA DE ORO' STELLA DE ORO DAYLILY	1 GAL	10
⊕	LAVANDULA X INTERMEDIA 'GROSSO' GROSSO LAVENDIN	1 GAL	32
GRASSES	BOTANICAL / COMMON NAME	SIZE	QTY
⊕	CALAMAGROSTIS X ACUTIFLORA 'KARL FOERSTER' KARL FOERSTER FEATHER REED GRASS	1 GAL	16
⊕	PANICUM VIRGATUM 'HOT ROD' HOT ROD SWITCH GRASS	1 GAL	18
GROUND COVERS	BOTANICAL / COMMON NAME	SIZE	QTY
▨	GRAVEL WITH PLANTS (WARM COLORS)	FLAT	1,563 SF
▨	PARKING LOT ISLANDS GRAVEL MULCH	FLAT	6,532 SF

NOTES:

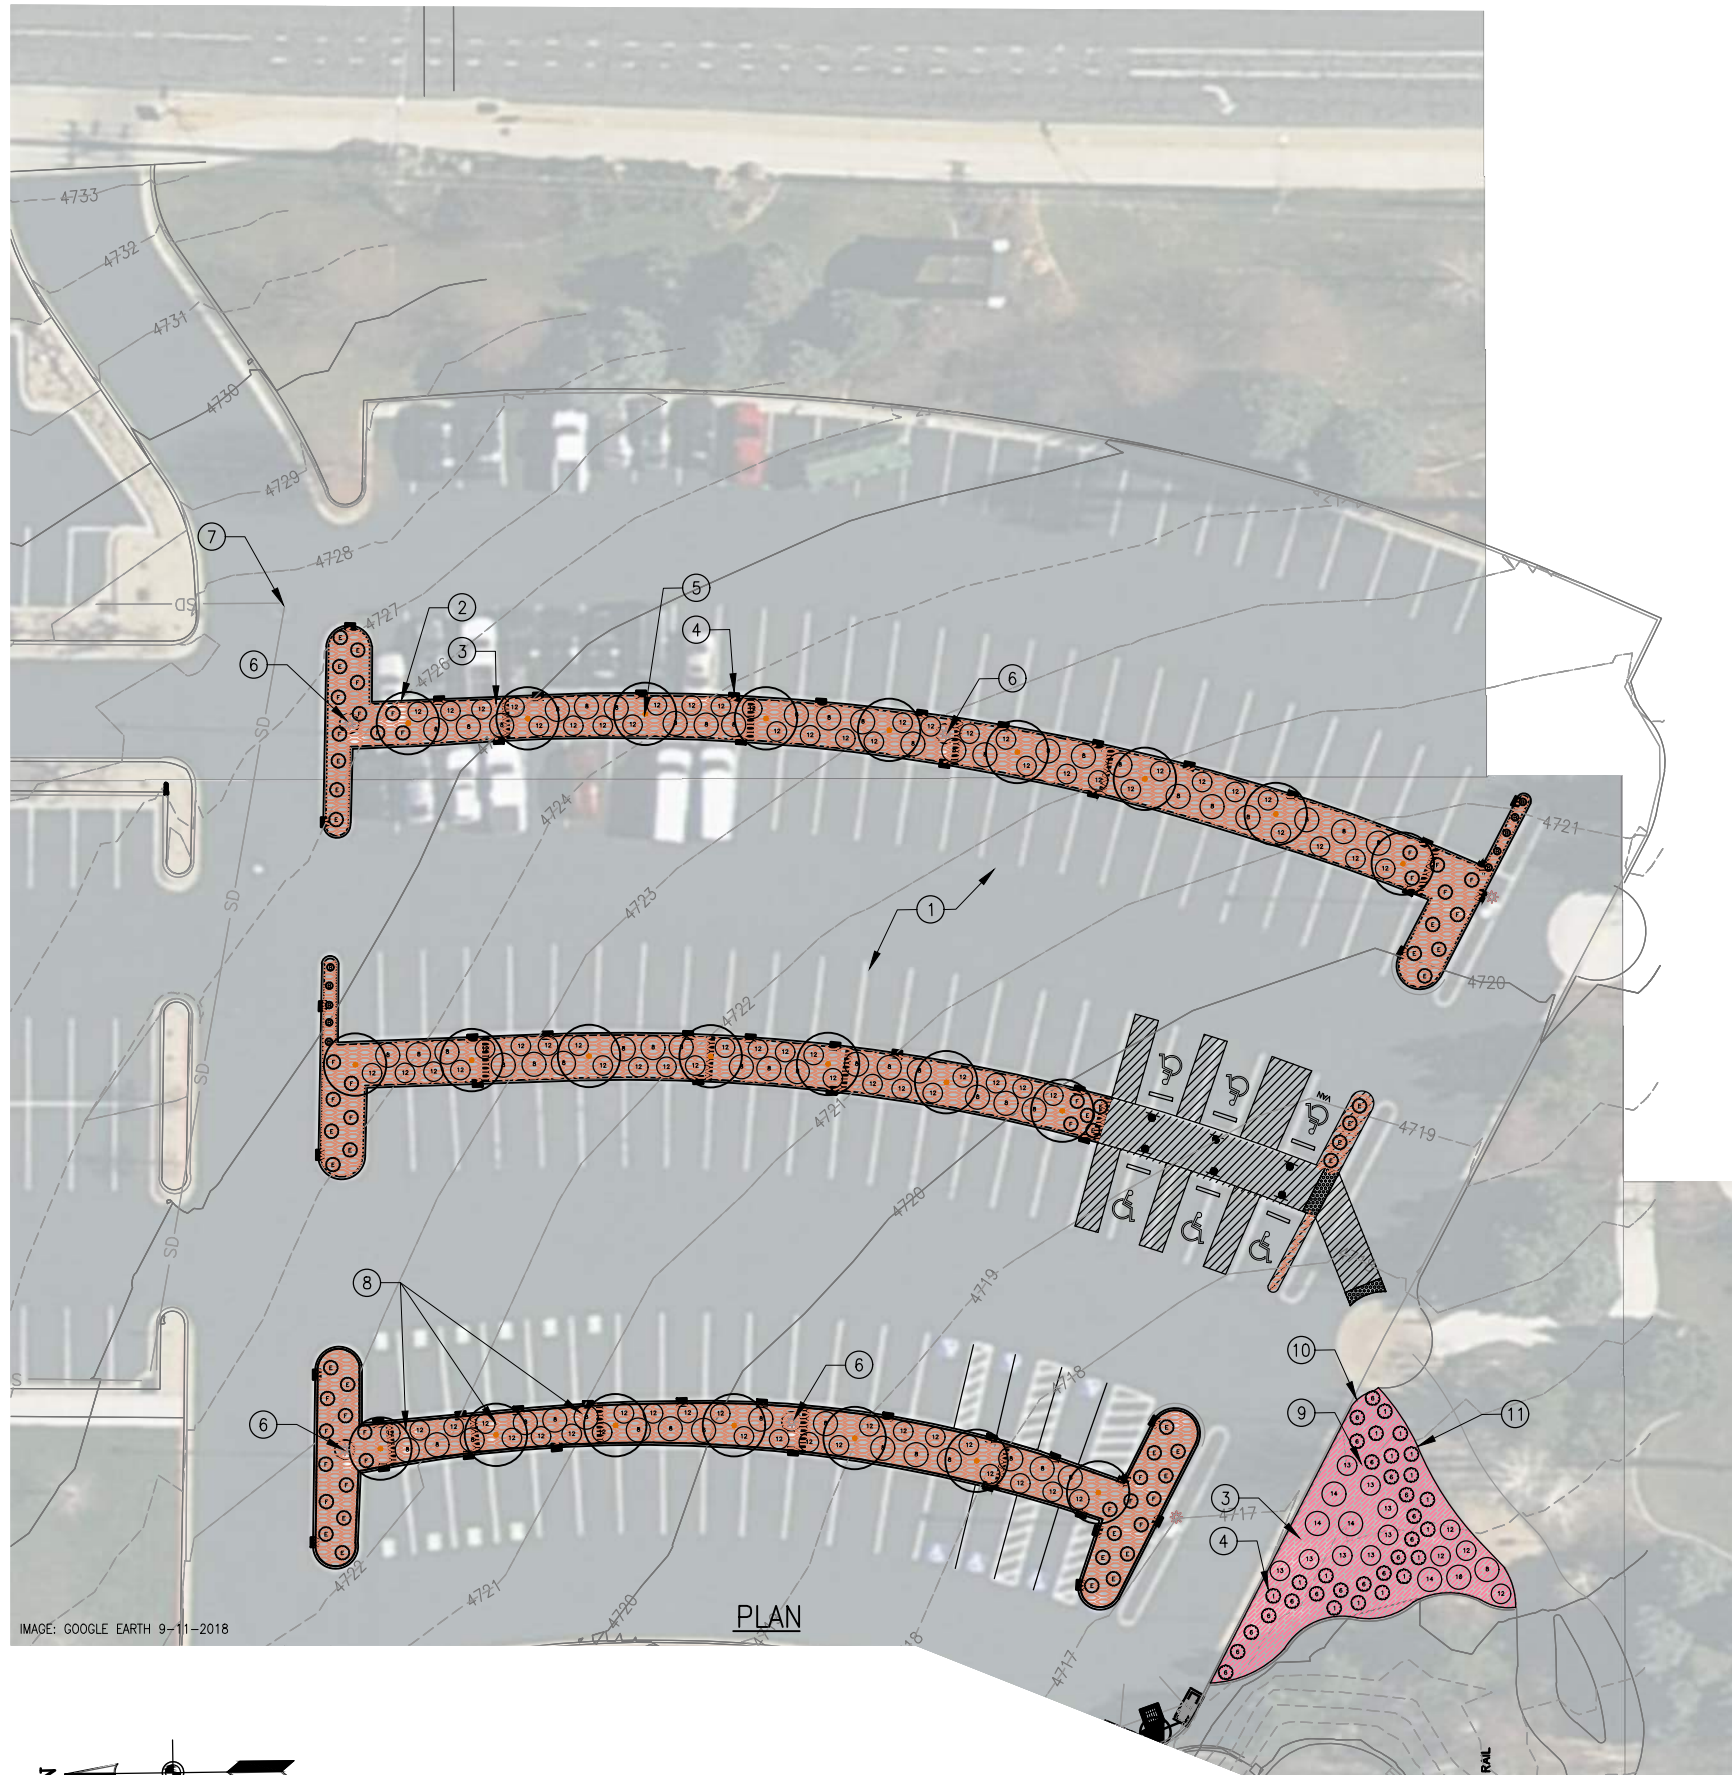- ① EXISTING ASPHALT PARKING TO REMAIN. PROTECT IN PLACE. REPLACE ANY PORTIONS OF CONCRETE SIDEWALK THAT ARE DAMAGED DURING CONSTRUCTION.
- ② INSTALL CONCRETE CURB AND GUTTER PER CIVIL PLANS.
- ③ INSTALL GRAVEL MULCH AT A DEPTH OF 6" WITH WEED BARRIER FABRIC WITHIN PARKING ISLANDS PER DETAIL ON SHEET L-08. (L 2815)
- ④ PLANT SHRUBS/PERENNIALS/ORNAMENTAL GRASSES PER DETAIL ON SHEET L-08. (L 2865)
- ⑤ PLANT TREES PER DETAIL ON SHEET L-08. (L 2858) (L 2859)
- ⑥ PRESERVE AND PROTECT EXISTING LIGHT POLE.
- ⑦ PRESERVE AND PROTECT EXISTING STORM DRAIN PIPE AND STRUCTURES.
- ⑧ PRESERVE AND PROTECT EV CHARGING STATIONS.
- ⑨ FLAGPOLE SPOTLIGHT TO BE REPAIRED OR REPLACED WITH A LIGHT ATTACHED TO FLAGPOLE BY CONTRACTOR.
- ⑩ REMOVE AND DISPOSE OF EXISTING TURF.
- ⑪ ALL LANDSCAPE AND IRRIGATION WORK WILL NEED TO MEET SANDY CITY STANDARDS AND SPECIFICATIONS. CONTACT THE FOLLOWING PARKS & RECREATION POINTS OF CONTACT TO SCHEDULE INSPECTIONS:
IRRIGATION: CHRIS KIRK AT 801-568-2914 (OFFICE) OR 801-842-7995 (CELL)
LANDSCAPING: JEREMY GARCIA AT 801-568-2903 (OFFICE) OR 801-803-4297 (MOBILE)

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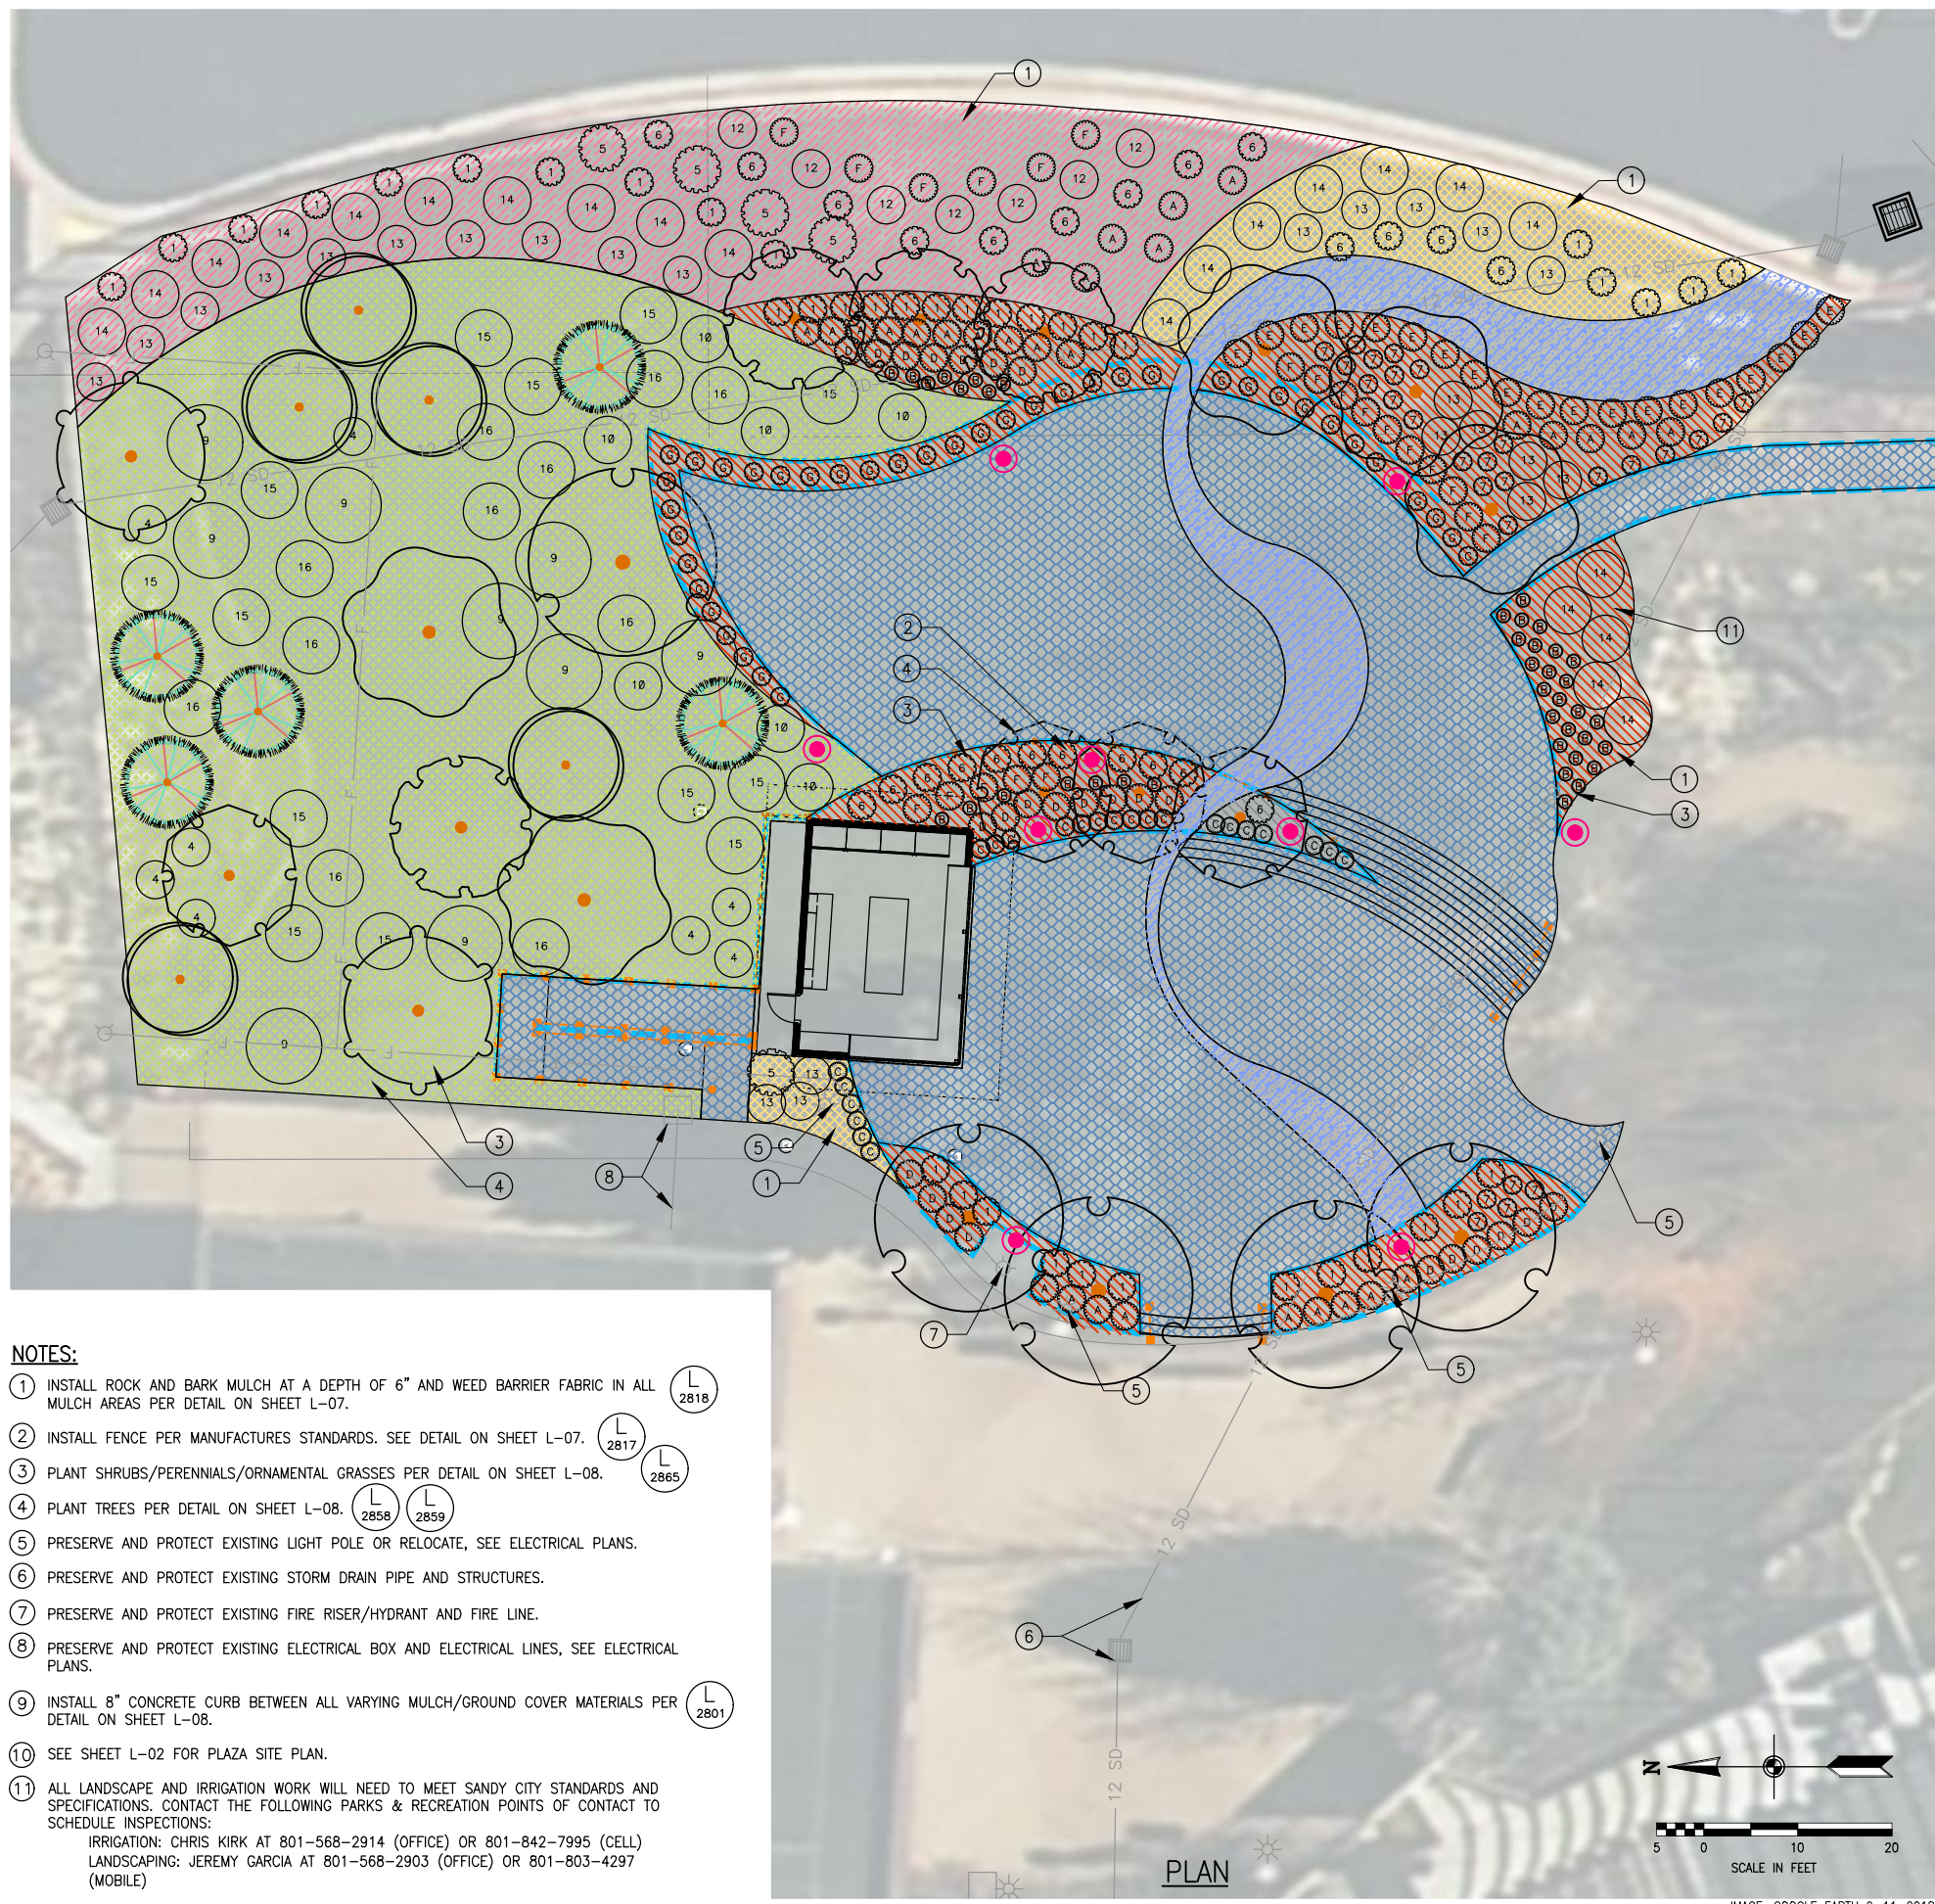
NO.	DATE	REV. BY	DESCRIPTION

VERIFY SCALE
BAR IS ONE INCH ON ORIGINAL DRAWING

REVIEW
CHECKED: J. TSANDES
APPROVED: J. TSANDES

DESIGN
DESIGN: C. GLABAU
DRAWN: C. GLABAU

LANDSCAPE
PARKING LOT LANDSCAPE PLAN
DATE: JUNE 2023
PROJECT NUMBER: 742-22-01



- NOTES:**
- ① INSTALL ROCK AND BARK MULCH AT A DEPTH OF 6" AND WEED BARRIER FABRIC IN ALL MULCH AREAS PER DETAIL ON SHEET L-07. L 2818
 - ② INSTALL FENCE PER MANUFACTURES STANDARDS. SEE DETAIL ON SHEET L-07. L 2817
 - ③ PLANT SHRUBS/PERENNIALS/ORNAMENTAL GRASSES PER DETAIL ON SHEET L-08. L 2865
 - ④ PLANT TREES PER DETAIL ON SHEET L-08. L 2858 L 2859
 - ⑤ PRESERVE AND PROTECT EXISTING LIGHT POLE OR RELOCATE, SEE ELECTRICAL PLANS.
 - ⑥ PRESERVE AND PROTECT EXISTING STORM DRAIN PIPE AND STRUCTURES.
 - ⑦ PRESERVE AND PROTECT EXISTING FIRE RISER/HYDRANT AND FIRE LINE.
 - ⑧ PRESERVE AND PROTECT EXISTING ELECTRICAL BOX AND ELECTRICAL LINES, SEE ELECTRICAL PLANS.
 - ⑨ INSTALL 8" CONCRETE CURB BETWEEN ALL VARYING MULCH/GROUND COVER MATERIALS PER DETAIL ON SHEET L-08. L 2801
 - ⑩ SEE SHEET L-02 FOR PLAZA SITE PLAN.
 - ⑪ ALL LANDSCAPE AND IRRIGATION WORK WILL NEED TO MEET SANDY CITY STANDARDS AND SPECIFICATIONS. CONTACT THE FOLLOWING PARKS & RECREATION POINTS OF CONTACT TO SCHEDULE INSPECTIONS:
 IRRIGATION: CHRIS KIRK AT 801-568-2914 (OFFICE) OR 801-842-7995 (CELL)
 LANDSCAPING: JEREMY GARCIA AT 801-568-2903 (OFFICE) OR 801-803-4297 (MOBILE)

PLANT SCHEDULE PLAZA			
TREES	BOTANICAL / COMMON NAME	SIZE	QTY
	ACER CINNALA 'FLAME' FLAME AMUR MAPLE	2" CAL	5
	ACER CRISEUM PAPERBARK MAPLE	2" CAL	5
	ACER TATARICUM 'GARANN' HOT WINGS® TATARIAN MAPLE	2" CAL	4
	FAGUS SYLVATICA 'TRICOLOR' TRICOLOR EUROPEAN BEECH	2" CAL	4
	PINUS LEUCODERMIS 'HEIDREICHII' BOSNIAN PINE	6'	5
	RHUS TYPHINA 'LACINATA' CUTLEAF STAGHORN SUMAC	6'	5
	SYRINGA RETICULATA 'IVORY SILK' IVORY SILK JAPANESE TREE LILAC	2" CAL	2
SHRUBS	BOTANICAL / COMMON NAME	SIZE	QTY
	ARTEMISIA TRIDENTATA BIG SAGEBRUSH	5 GAL	13
	CARYOPTERIS X CLANDONENSIS 'LONGWOOD BLUE' LONGWOOD BLUE BLUEBEARD	5 GAL	24
	ERICAMERIA NAUSEOSA RUBBER RABBITBRUSH	5 GAL	11
	MAHONIA AQUIFOLIUM 'COMPACTA' COMPACT OREGON GRAPE	5 GAL	8
	PHYSOCARPUS OPULIFOLIUS 'NUGGET' NUGGET NINEBARK	5 GAL	22
	POTENTILLA FRUTICOSA 'GOLDFINGER' GOLDFINGER BUSH CINQUEFOIL	5 GAL	7
	RHUS AROMATICA 'GRO-LOW' GRO-LOW FRAGRANT SUMAC	5 GAL	9
	RIBES ALPINUM ALPINE CURRANT	5 GAL	7
ANNUALS/PERENNIALS	BOTANICAL / COMMON NAME	SIZE	QTY
	CENTRANTHUS RUBER 'ROSEUS' PINK VALERIAN	1 GAL	19
	HEMEROCALLIS X 'HYPERION' HYPERION DAYLILY	1 GAL	30
	HEMEROCALLIS X 'STELLA DE ORO' STELLA DE ORO DAYLILY	1 GAL	40
	LAVANDULA X INTERMEDIA 'GROSSO' GROSSO LAVENDIN	1 GAL	21
	LINUM LEWISII 'BLUE FLAX' BLUE FLAX	1 GAL	23
	RUDBECKIA FULGIDA SULLIVANTII 'GOLDSTURM' GOLDSTURM CONEFLOWER	1 GAL	25
GRASSES	BOTANICAL / COMMON NAME	SIZE	QTY
	CALAMAGROSTIS X ACUTIFLORA 'KARL FOERSTER' KARL FOERSTER FEATHER REED GRASS	1 GAL	39
	MISCANTHUS SINENSIS 'PURPURESCENS' PURPLE EULALIA GRASS	1 GAL	5
	PANICUM VIRGATUM 'HOT ROD' HOT ROD SWITCH GRASS	1 GAL	24
	PENNISETUM ALOPECUROIDES 'HAMELN' HAMELN FOUNTAIN GRASS	1 GAL	27
	PENNISETUM ALOPECUROIDES 'PIGLET' PIGLET DWARF FOUNTAIN GRASS	1 GAL	39
GROUND COVERS	BOTANICAL / COMMON NAME	SIZE	QTY
	BARK MULCH	NONE	2,405 SF
	EXPOSED CONCRETE AGGREGATE	NONE	971 SF
	GRAVEL WITH PLANTS (MULTI-COLORED)	FLAT	778 SF
	GRAVEL WITH PLANTS (WARM COLORS)	FLAT	2,047 SF
	NATURAL OPEN SPACE LANDSCAPE	SOD	5,748 SF
	PATTERNED CONCRETE	FLAT	5,849 SF

BOWEN COLLINS ASSOCIATES

60% REVIEW

NOT FOR CONSTRUCTION FOR REVIEW ONLY

NO.	DATE	REV. BY	DESCRIPTION

VERIFY SCALE
BAR IS ONE INCH ON ORIGINAL DRAWING

REVIEW
CHECKED: J. TSANDES
APPROVED: J. TSANDES

DESIGN
DESIGN: C. GLABAU
DRAWN: C. GLABAU

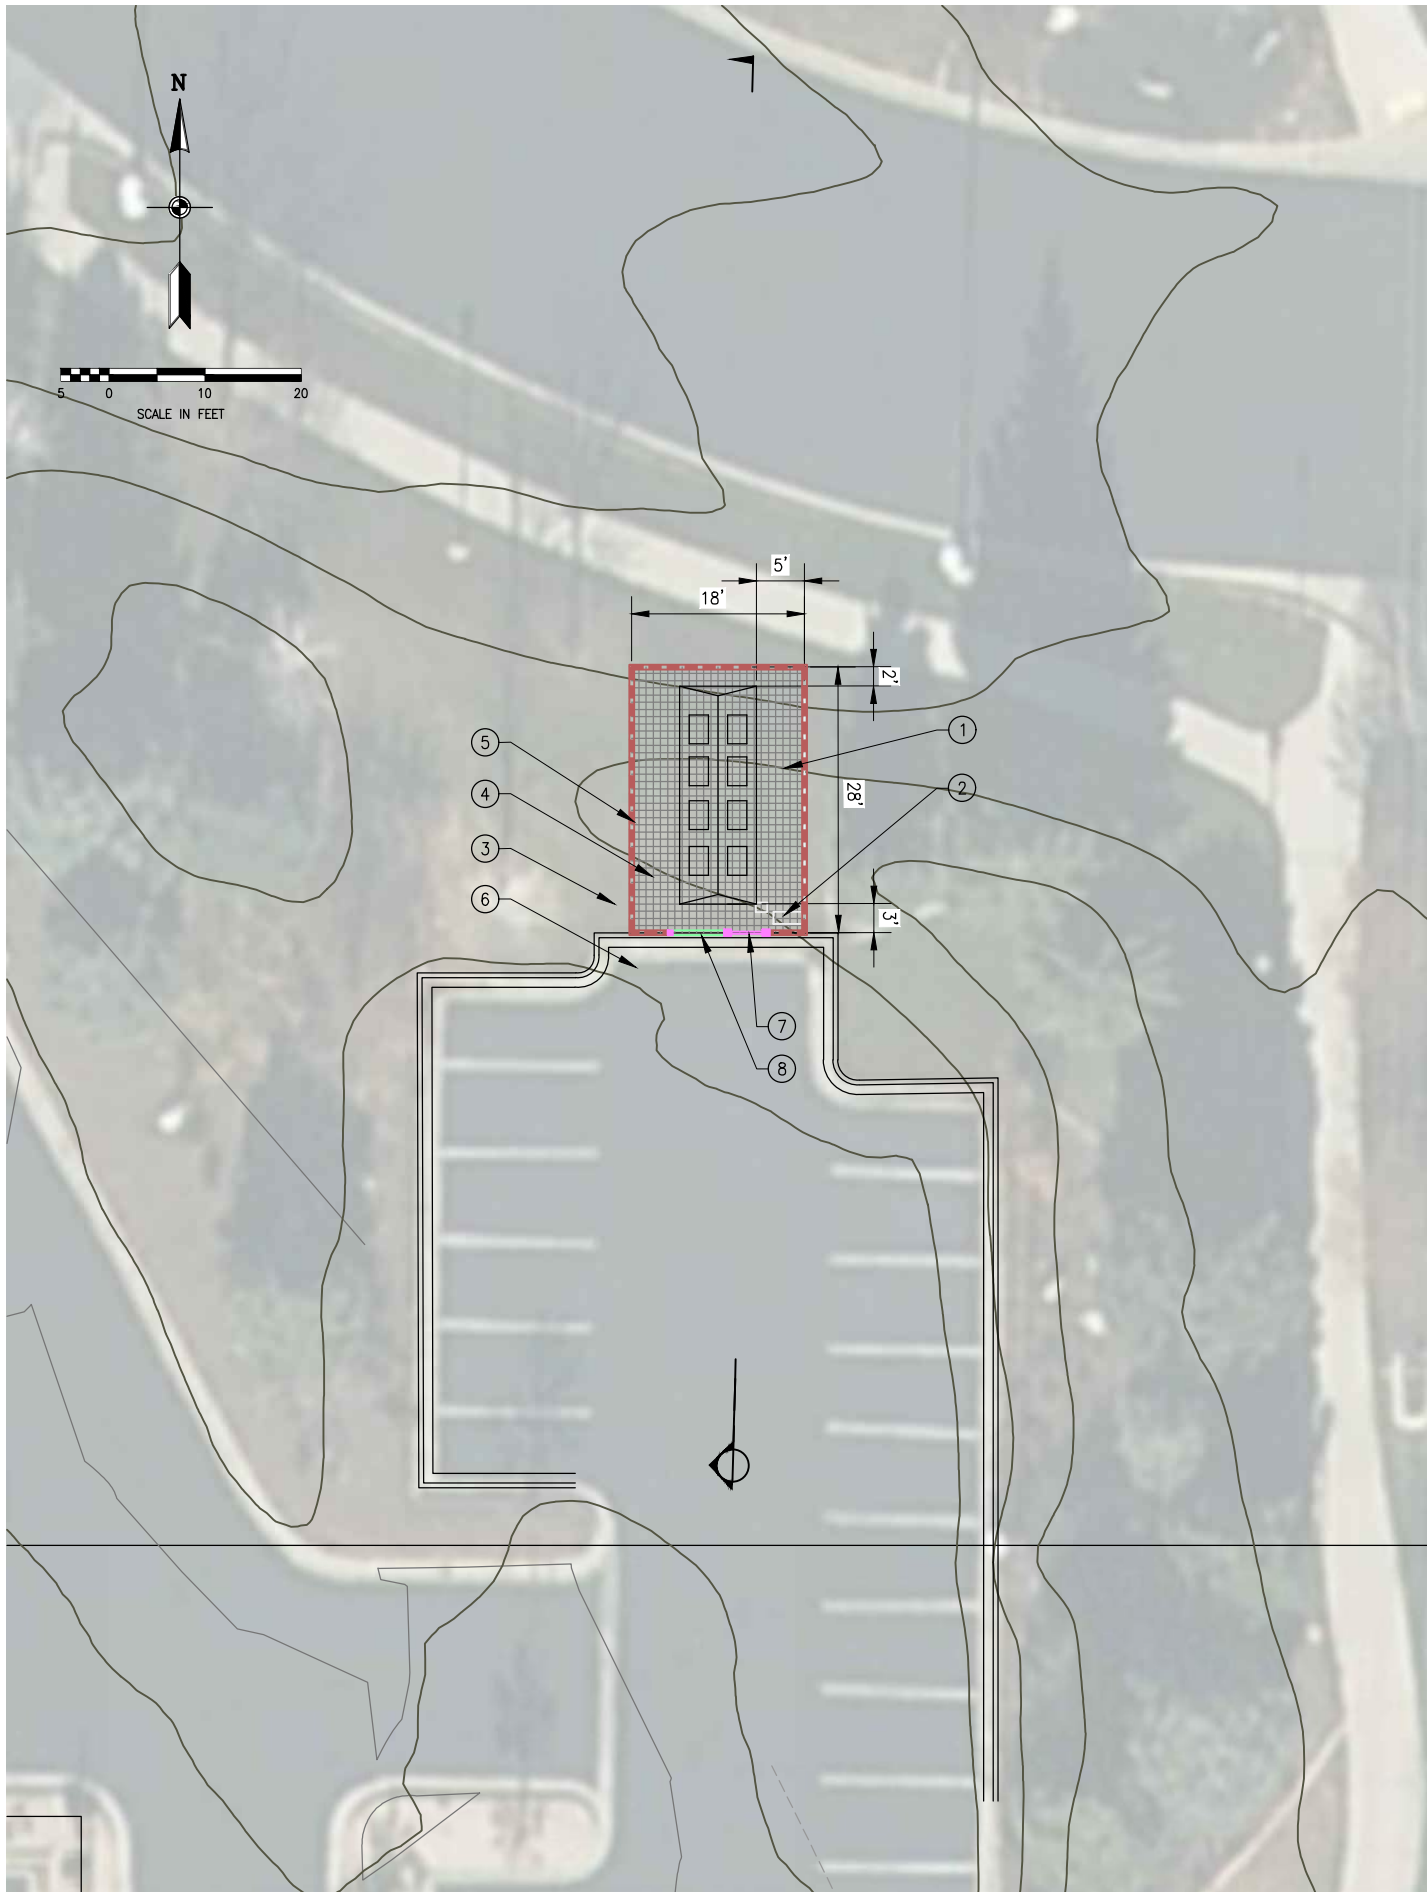
SANDY CITY COMMUNITY ARTS
SANDY CITY AMPHITHEATER
SANDY, UT

LANDSCAPE
PLAZA LANDSCAPE PLAN

DRAWING NO.
L-04


DATE: JUNE 2023
PROJECT NUMBER: 742-22-01

SHEET **19** OF **26**



NOTES:

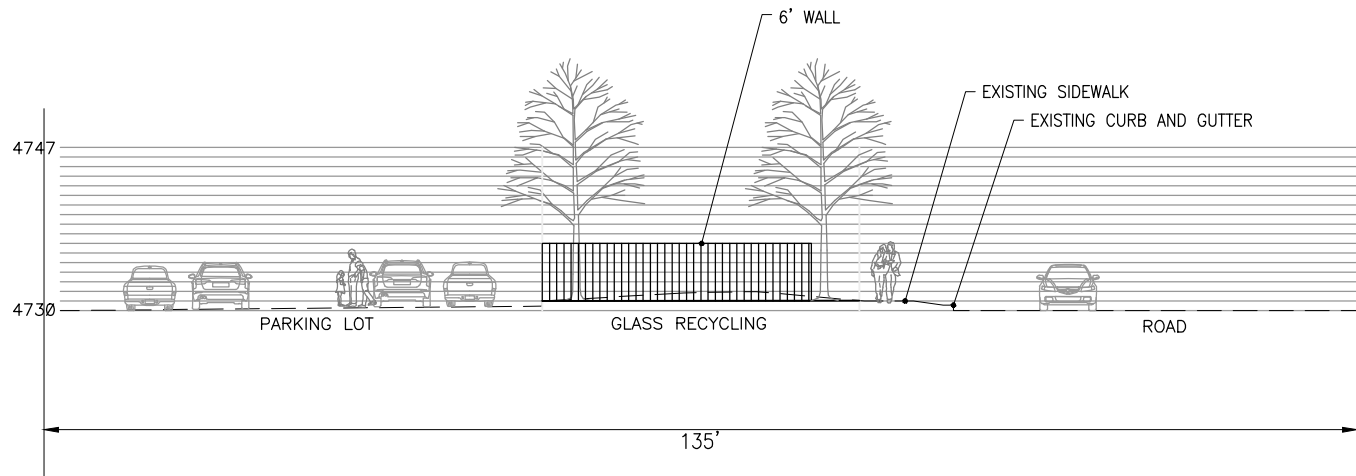- ① CLEAR AND DISPOSE OF EXISTING TURF GRASS. EXCAVATE FOR FLAT SURFACE.
- ② CONTRACTOR TO RELOCATE IRRIGATION VALVE BOXES AND VERIFY IRRIGATION IS FULLY FUNCTIONING WITH HEAD TO HEAD COVERAGE IN THE SURROUNDING LANDSCAPE AREA.
- ③ CONTRACTOR TO REPLACED ALL DISTURBED AREAS WITH SOD TO MATCH EXISTING.
- ④ INSTALL 4" THICK CONCRETE PAD FOR DUMPSTER PER SANDY CITY STANDARD SW-03 ON DRAWING C-04.
- ⑤ INSTALL 6" CMU CONCRETE WALL AROUND PERIMETER OF CONCRETE PAD PER SANDY CITY STANDARDS. SEE SHEET L-09.
- ⑥ CONTRACTOR TO REPAIR ANY DAMAGED CONCRETE AND ASPHALT TO MATCH EXISTING.
- ⑦ INSTALL 6' x 6' OPAQUE GATE WITH SOLID METAL FRAMES OR OTHER DURABLE MATERIAL APPROVED BY THE CITY. POSTS TO ALLOW FOR OPENING FROM THE CENTER. REMOVABLE CENTER POST FOR DUMPSTER REMOVAL.
- ⑧ INSTALL 4' x 6' OPAQUE MAN GATE WITH SOLID METAL FRAMES OF OTHER DURABLE MATERIAL APPROVED BY THE CITY. POSTS TO ALLOW FOR OPENING FROM THE CENTER. REMOVABLE CENTER POSTS FOR DUMPSTER REMOVAL.



SECTION A-A
SCALE: NTS



60% REVIEW

NOT FOR CONSTRUCTION
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NO.	DATE	REV. BY	DESCRIPTION

SANDY CITY COMMUNITY ARTS
SANDY CITY AMPHITHEATER
SANDY, UT

DESIGN DESIGNER: J. TSANDES DRAWN: C. GLABAU	REVIEW CHECKED: J. TSANDES APPROVED: J. TSANDES	<p style="font-size: small;">VERIFY SCALE BAR IS ONE INCH ON ORIGINAL DRAWING</p>
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LANDSCAPE
GLASS RECYCLING SITE PLAN

DATE: JUNE 2023 PROJECT NUMBER: 742-22-01

P:\Sandy City Community Arts\742-22-01 - Sandy City Amphitheater\2.0 Design Phase\2.7 Drawings\742-22-01_L-05.dwg Plotted: 6/22/2023 2:51 PM By: Cara Glabau



CMU BLOCK
TO MATCH
EXISTING



WOOD SIDING
& SOFFIT



STEEL PLATE
ACCENTS



METAL ROOFING
TO MATCH
EXISTING



CMU BLOCK
TO MATCH
EXISTING



WOOD SIDING
& SOFFIT



STEEL PLATE
ACCENTS



METAL ROOFING
TO MATCH
EXISTING



CMU BLOCK
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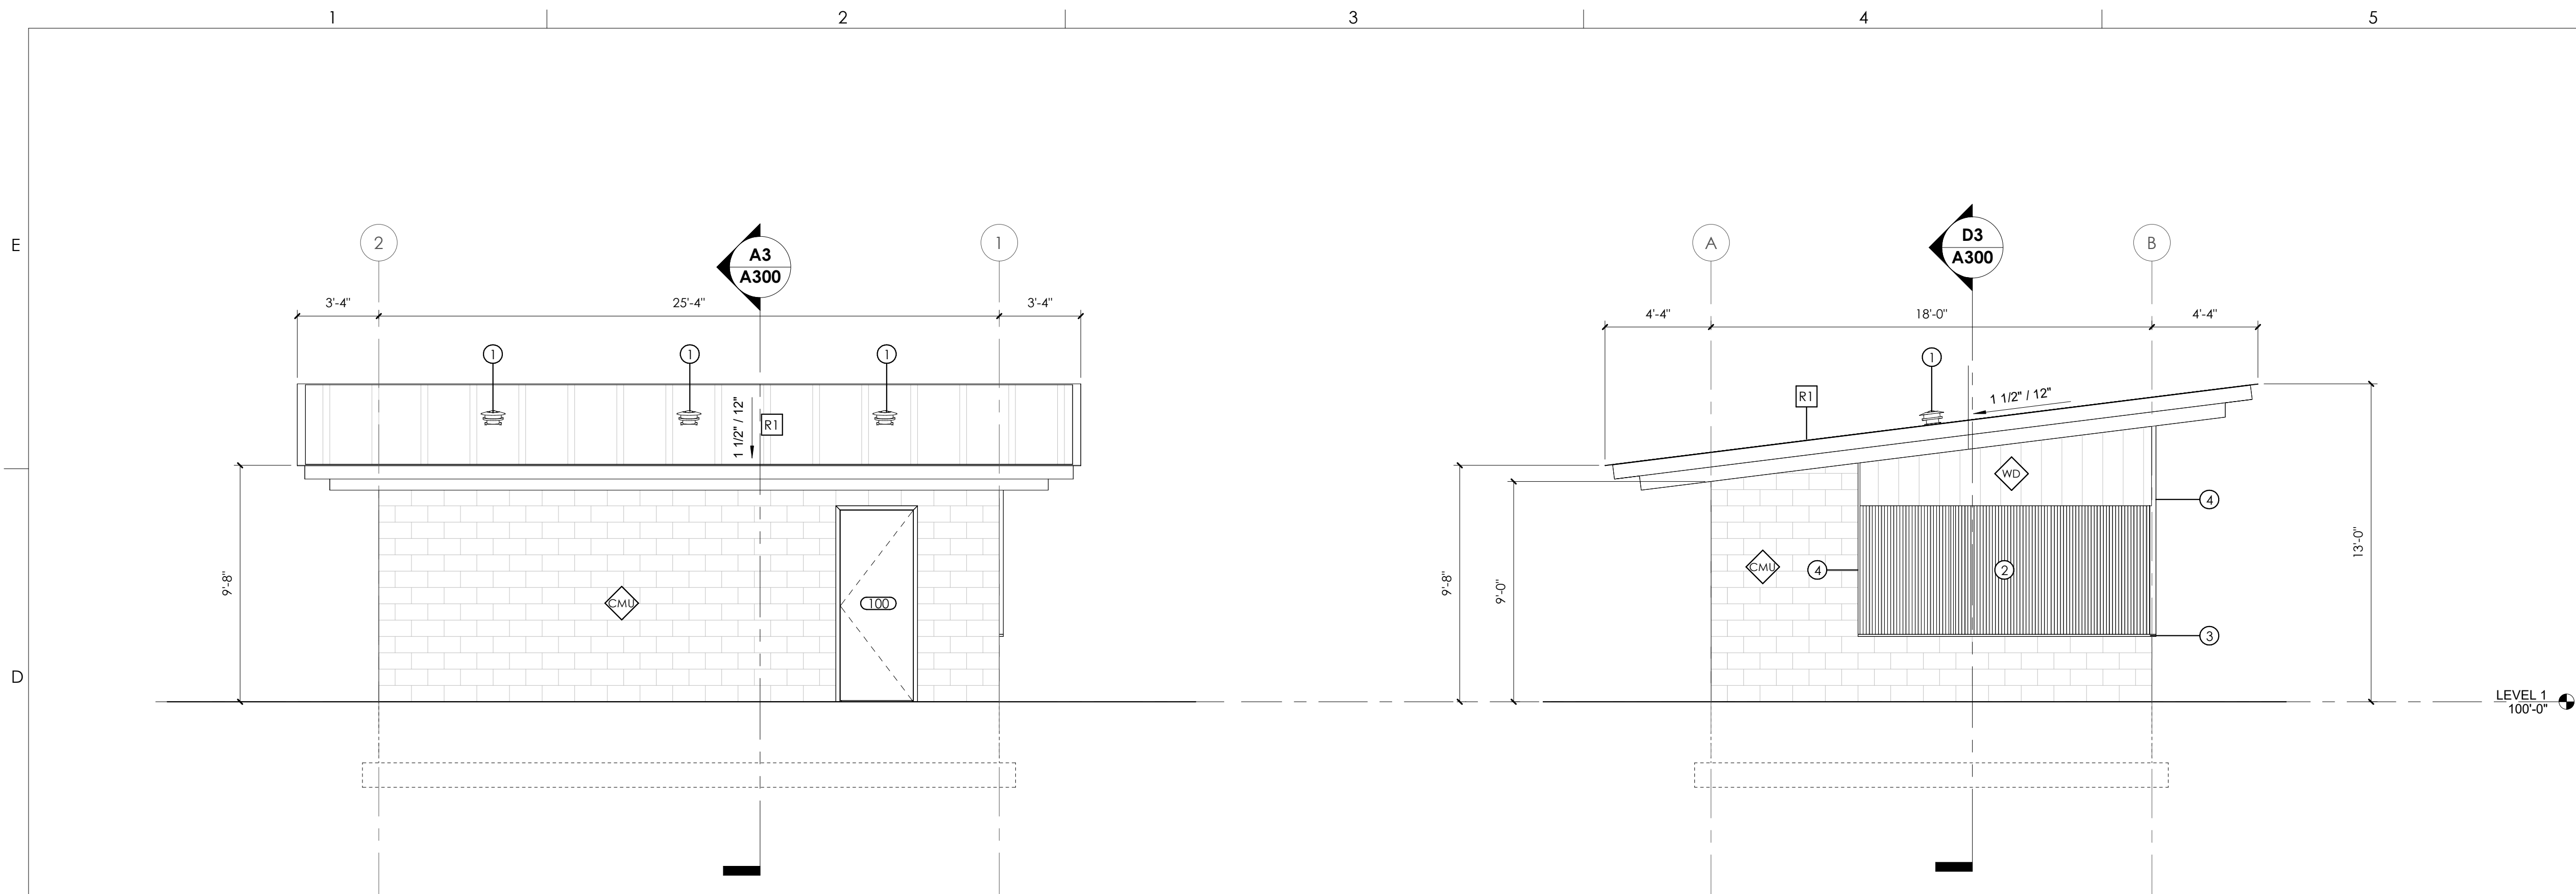
WOOD SIDING
& SOFFIT



STEEL PLATE
ACCENTS

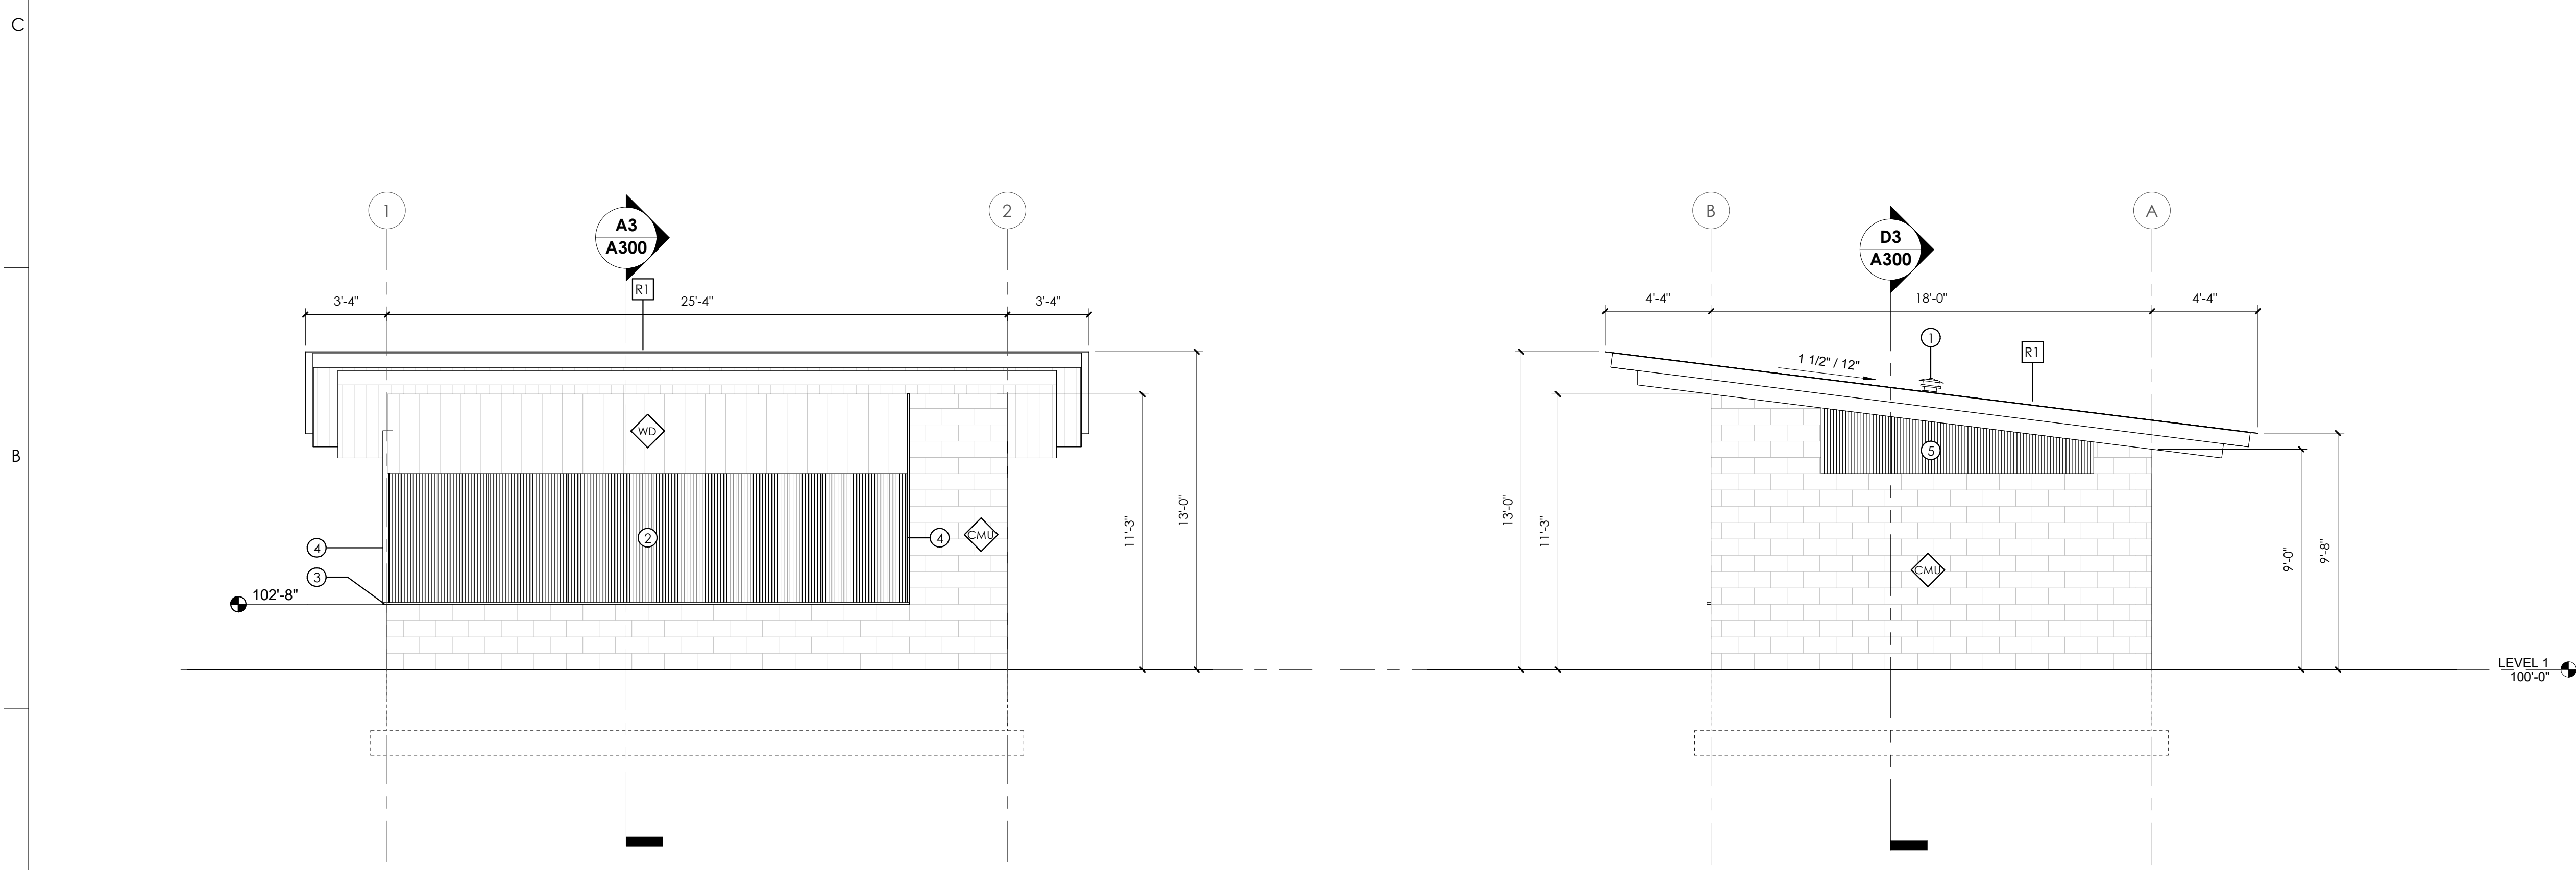


METAL ROOFING
TO MATCH
EXISTING



D1 NORTH ELEVATION
1/4" = 1'-0"

D4 WEST ELEVATION
1/4" = 1'-0"



A1 SOUTH ELEVATION
1/4" = 1'-0"

A4 EAST ELEVATION
1/4" = 1'-0"

GENERAL NOTES:

SEE SHEET GI001 FOR DRAWING INDEX.
SEE SHEET GI002 FOR GENERAL NOTES AND ABBREVIATIONS.
DO NOT SCALE DRAWINGS.
CONTRACTOR / SUBCONTRACTOR SHALL VERIFY ALL DIMENSIONS AND CONDITIONS BEFORE BEGINNING WORK, AND SHALL REPORT TO THE ARCHITECT ANY ERRORS, INCONSISTENCIES OR OMISSIONS BEFORE BEGINNING WORK. SEE GENERAL NOTES AND SPECIFICATIONS.

ELEVATION FINISHES

CMU BLOCK WALL - PAINTED	
EXTERIOR WOOD SIDING - SEALED	
BREAK METAL FASCIA - PRE-FINISHED	

KEYED NOTES:

- 1 EXHAUST FAN. SEE MECHANICAL DRAWINGS.
- 2 OPERABLE LIFTING STEEL AND WOOD DOOR PANEL
- 3 STEEL COUNTER TOP.
- 4 STEEL PLATE SURROUND
- 5 WALL VENTILATION. TBD.

**CIRQUE
STUDIO
ARCHITECTS**

1255 Iron Horse Dr.
Park City, UT 84060
ph: 435.901.4139
studio@thecirquestudio.com

**PRELIMINARY
NOT FOR
PERMIT OR
CONSTRUCTION**

**SANDY AMPHITHEATER
CONCESSIONS PAVILION**

1245 E 9400 S
SANDY, UT 84094

PROJECT #:
22-26
ISSUE DATE:
06.20.2023
ISSUE:
SCHEMATIC
REVISIONS
1 - T.B.D.

ELEVATIONS

A201



CMU BLOCK
TO MATCH
EXISTING



WOOD SIDING
& SOFFIT



STEEL PLATE
ACCENTS



METAL ROOFING
TO MATCH
EXISTING



CMU BLOCK
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WOOD SIDING
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STEEL PLATE
ACCENTS



METAL ROOFING
TO MATCH
EXISTING

GENERAL NOTES:




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ELEVATION FINISHES

CMU BLOCK WALL - PAINTED	
EXTERIOR WOOD SIDING - SEALED	
BREAK METAL FASCIA - PRE-FINISHED	

KEYED NOTES:

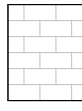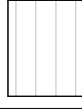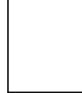- 1 STEEL PLATE SURROUND
- 2 OPERABLE LIFTING STEEL AND WOOD DOOR PANEL
- 3 STEEL PLATE SURROUND

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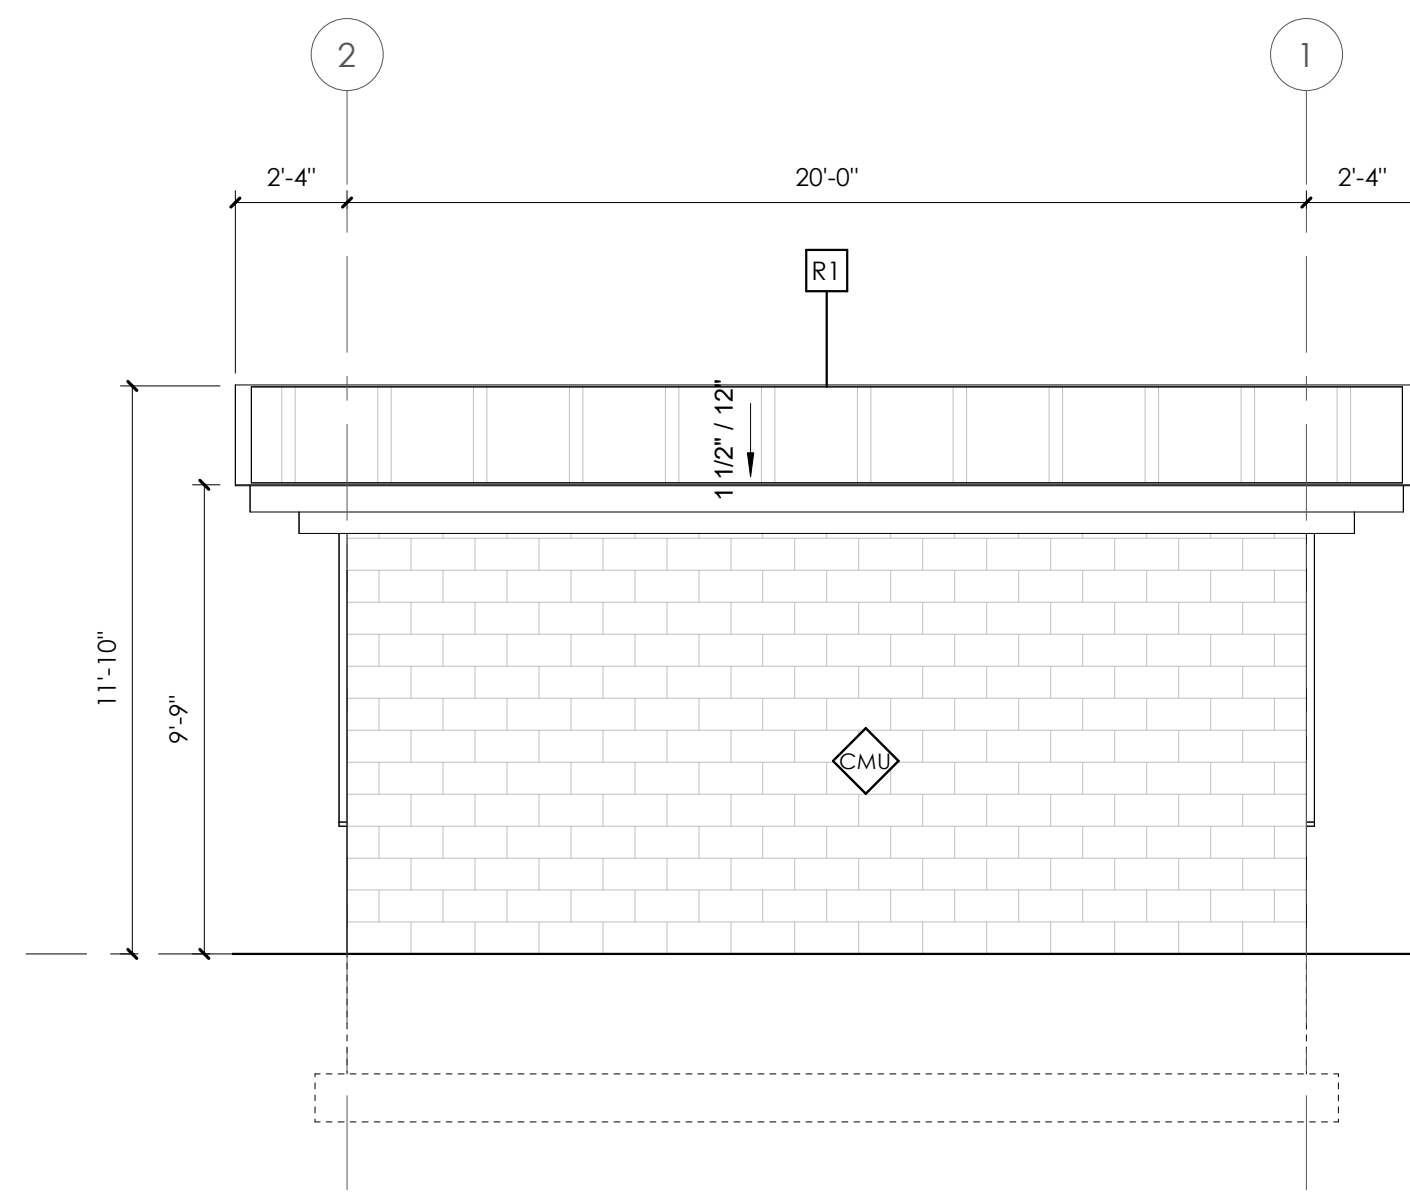
SANDY AMPHITHEATER
MERCH PAVILION

1245 E 9400 S
SANDY, UT 84094


PROJECT #:
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SCHEMATIC
REVISIONS

ELEVATIONS


A201




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STEEL PLATE
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STEEL PLATE
ACCENTS

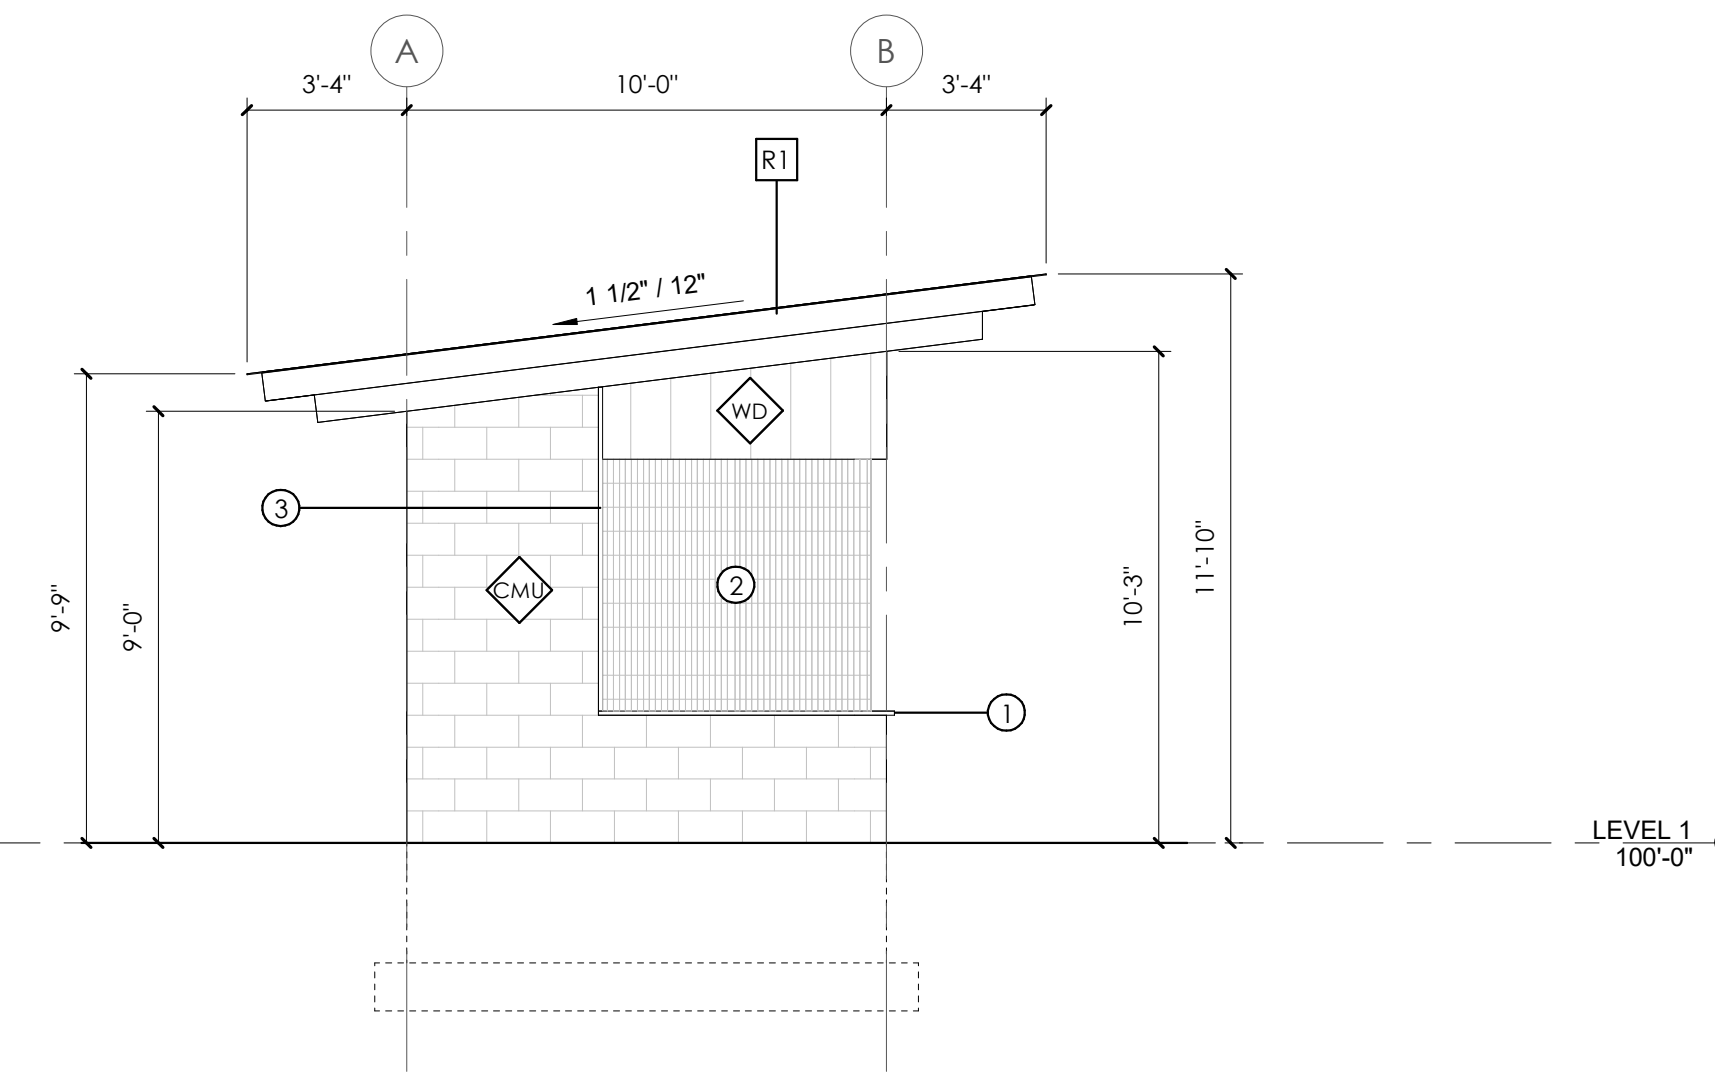

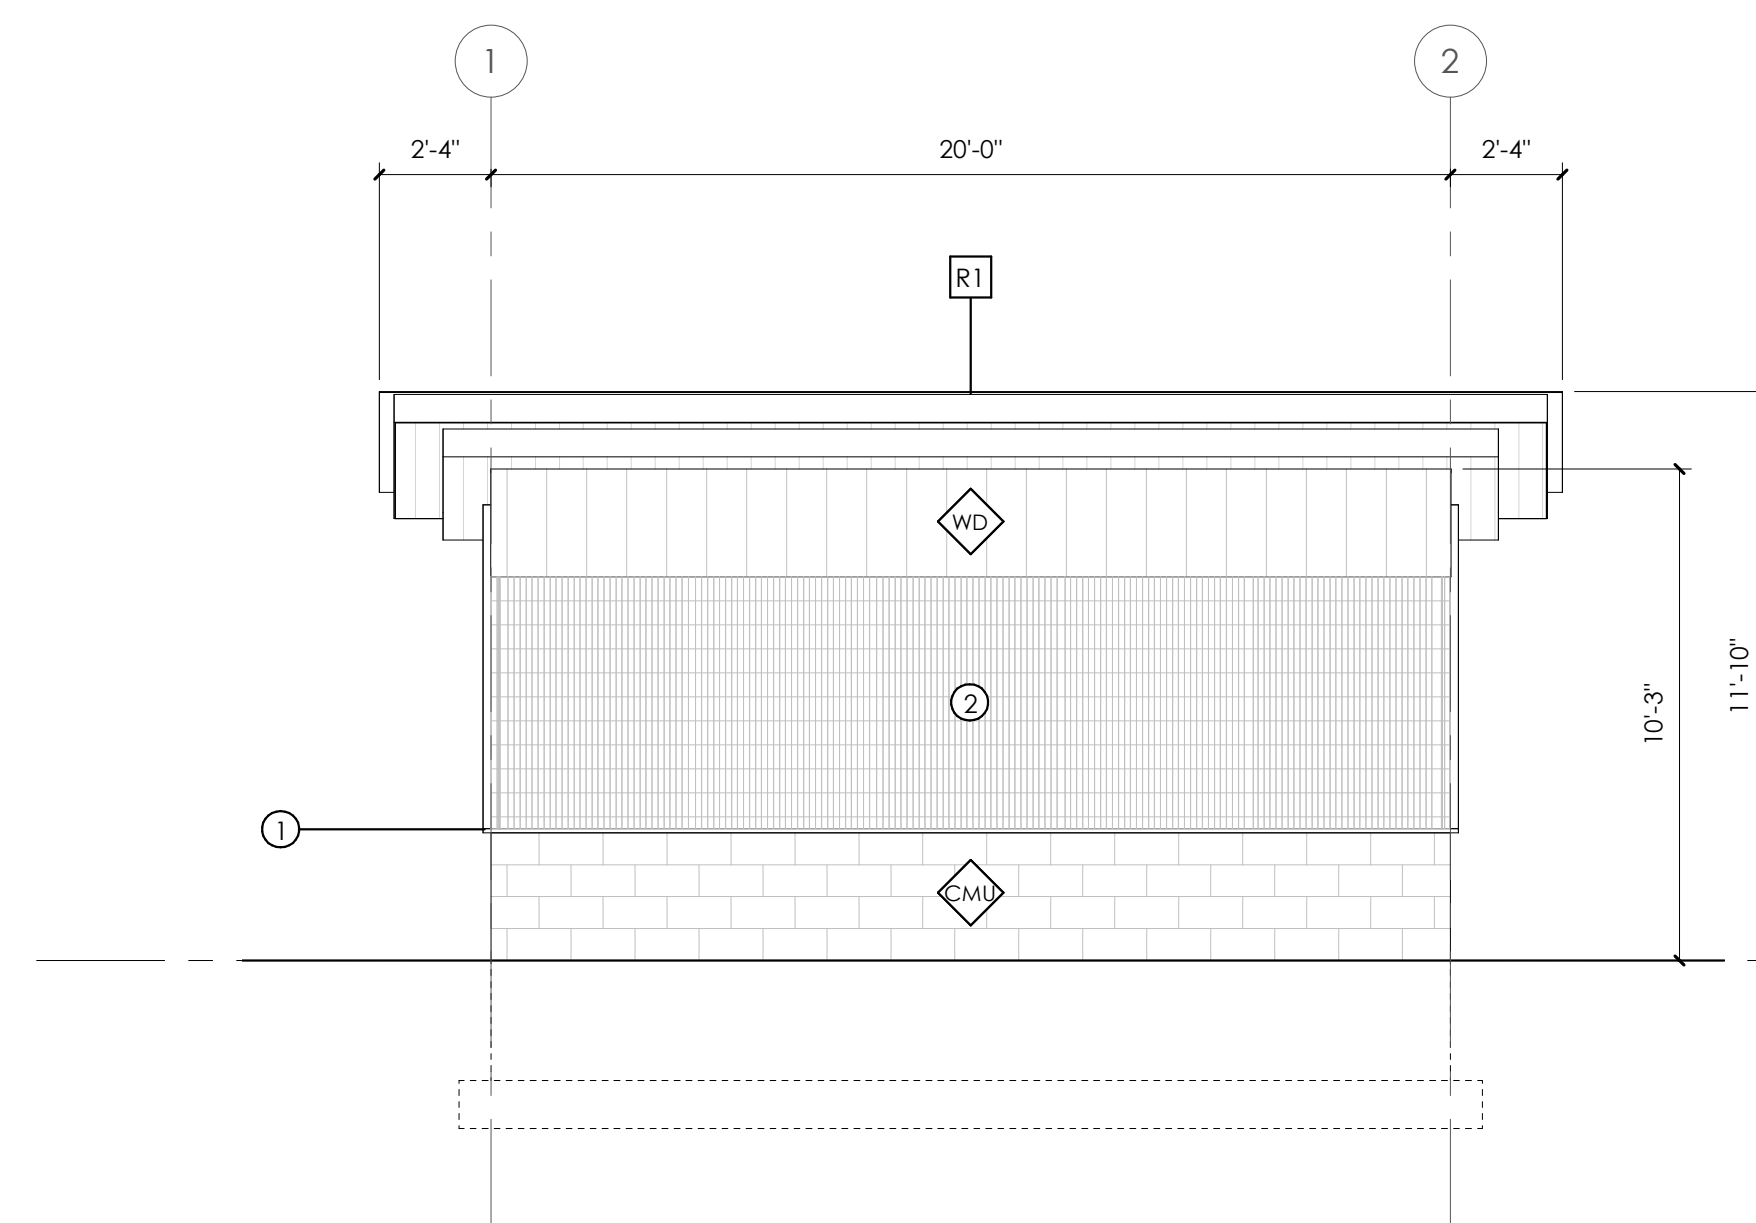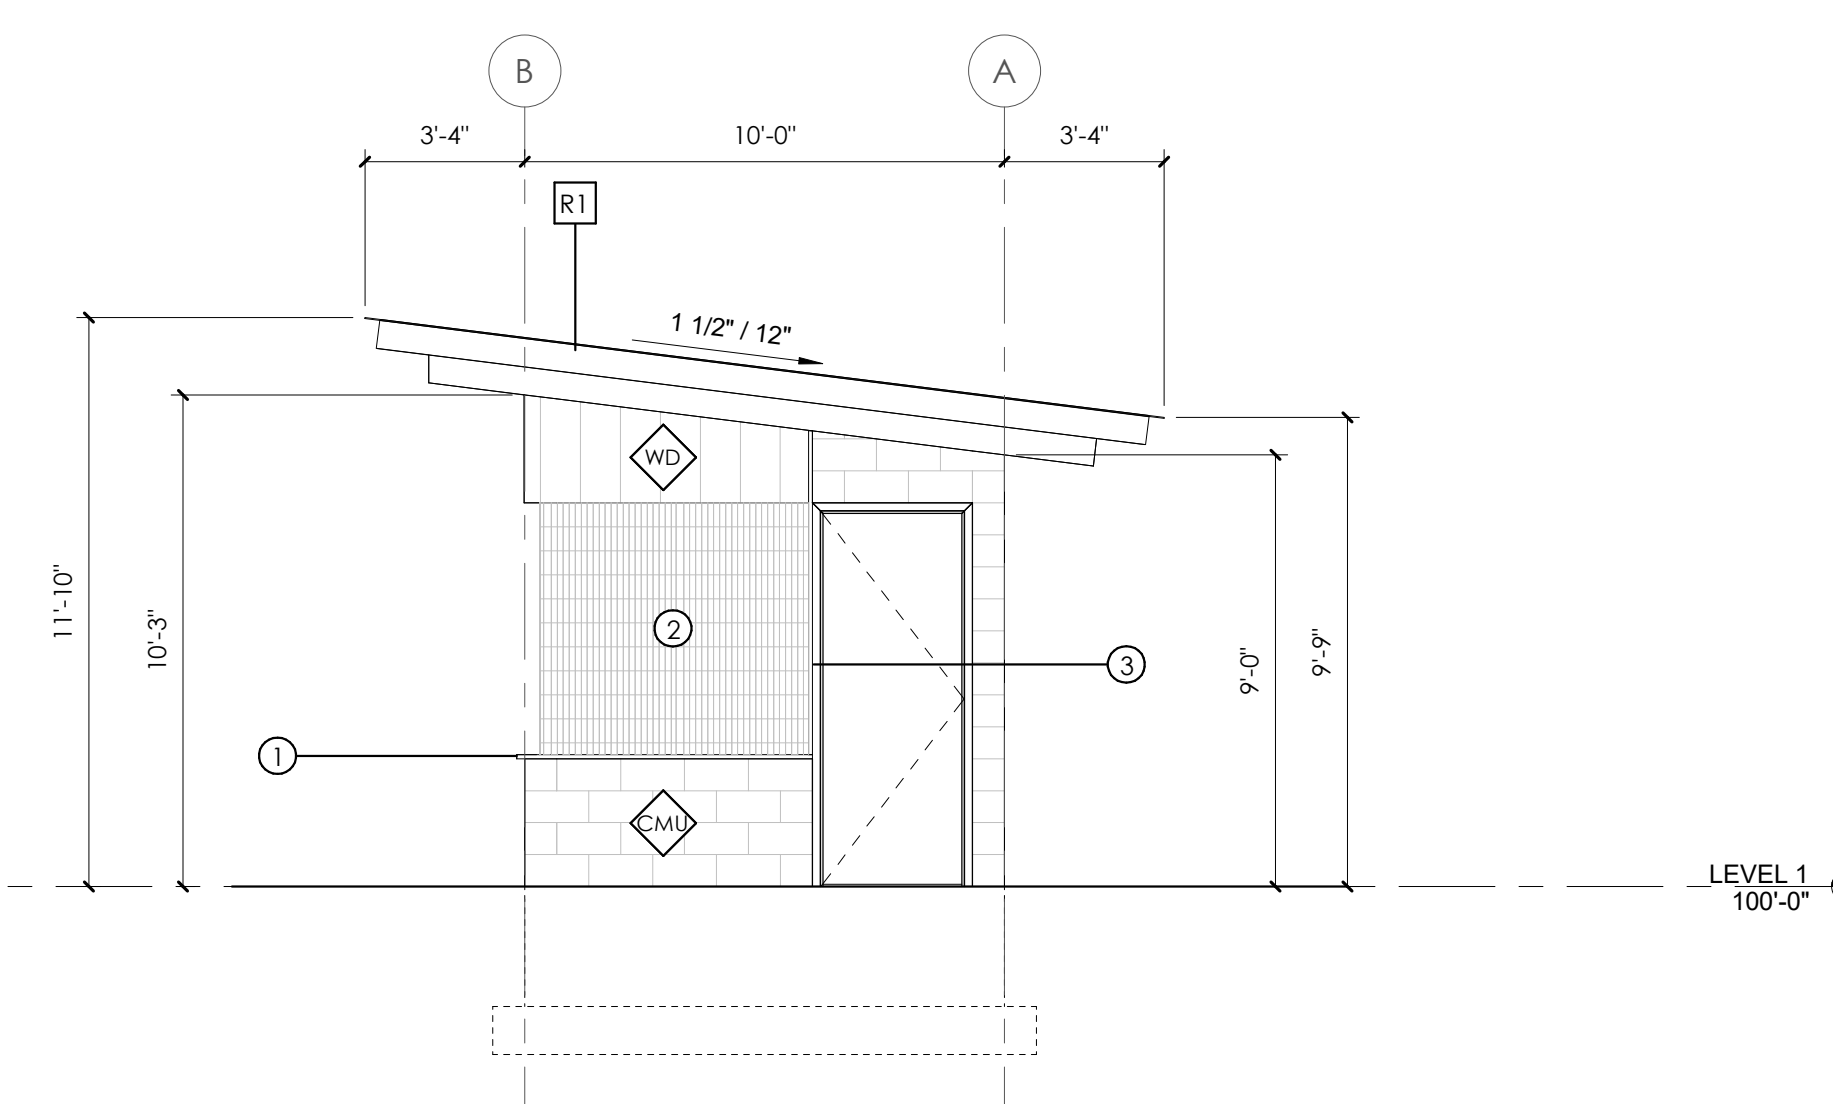METAL ROOFING
TO MATCH
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